


CUSTOM DUPLEX GROUND UP

861-63 5TH STREET

DOOR SCHEDULE:										
NO.	PAIR	WIDTH	HEIGHT	MATERIAL	FINISH	GLASS	MFR.	TINT	OPERATION	REMARKS
001	-	28"	6'-8"	AZEK	T.B.D.	-	T.B.D.	-	SWING	SHOWER DOOR TO FABRICATED BY G.C. (REFER TO EXTERIOR ELEVATIONS)
002	-	36"	6'-8"	FIBGLSS	T.B.D.	TEMP	T.B.D.	LOW-E	SWING	SIDE ENTRY DOOR
003	-	32"	6'-8"	FIBGLSS	T.B.D.	-	T.B.D.	-	SWING	
004	YES	72"	6'-8"	FIBGLSS	T.B.D.	-	T.B.D.	-	FRENCH	
005	YES	36"	6'-8"	FIBGLSS	T.B.D.	-	T.B.D.	-	FRENCH	
006	-	32"	6'-8"	FIBGLSS	T.B.D.	-	T.B.D.	-	SWING	
007	-	36"	6'-8"	FIBGLSS	T.B.D.	-	T.B.D.	-	SWING	SOLID CORE 1 HOUR FIRE RATED DOOR
008	-	36"	6'-8"	FIBGLSS	T.B.D.	TEMP	T.B.D.	LOW-E	SWING	
009	-	32"	6'-8"	FIBGLSS	T.B.D.	-	T.B.D.	-	SWING	SOLID CORE 1 HOUR FIRE RATED DOOR
010	-	28"	6'-8"	AZEK	T.B.D.	-	T.B.D.	-	SWING	SHOWER DOOR TO FABRICATED BY G.C. (REFER TO EXTERIOR ELEVATIONS)
011	-	32"	6'-8"	FIBGLSS	T.B.D.	-	T.B.D.	-	SWING	
012	-	32"	6'-8"	FIBGLSS	T.B.D.	-	T.B.D.	-	SWING	SOLID CORE 1 HOUR FIRE RATED DOOR
013	-	108"	7'-0"	FIBGLSS	T.B.D.	-	T.B.D.	-	OVERHEAD	GARAGE DOOR
014	-	108"	7'-0"	FIBGLSS	T.B.D.	-	T.B.D.	-	OVERHEAD	GARAGE DOOR
015	-	36"	6'-8"	AZEK	T.B.D.	-	T.B.D.	-	SWING	(REFER TO EXTERIOR ELEVATIONS)
016	-	36"	6'-8"	AZEK	T.B.D.	-	T.B.D.	-	SWING	(REFER TO EXTERIOR ELEVATIONS)
101	-	36"	6'-8"	FIBGLSS	T.B.D.	TEMP	THERMATRU	LOW-E	SWING	36" FRONT DOOR WITH 14" SIDE LITES AND TRANSOM ABOVE
102	-	24"	6'-8"	MASONITE	T.B.D.	-	T.B.D.	-	SWING	
103	-	34"	6'-8"	MASONITE	T.B.D.	-	T.B.D.	-	SWING	1 HOUR FIRE RATED
104	-	32"	6'-8"	MASONITE	T.B.D.	-	T.B.D.	-	SWING	
105	-	24"	6'-8"	MASONITE	T.B.D.	-	T.B.D.	-	SWING	LOUVERED @ HWH
106	-	32"	6'-8"	MASONITE	T.B.D.	-	T.B.D.	-	SWING	
107	-	32"	6'-8"	MASONITE	T.B.D.	-	T.B.D.	-	SWING	
108	YES	36"	6'-8"	MASONITE	T.B.D.	-	T.B.D.	-	FRENCH	LOUVERED
109	-	32"	6'-8"	MASONITE	T.B.D.	-	T.B.D.	-	SWING	
110	-	30"	6'-8"	MASONITE	T.B.D.	-	T.B.D.	-	SWING	
111	-	30"	6'-8"	MASONITE	T.B.D.	-	T.B.D.	-	SWING	
112	-	32"	6'-8"	MASONITE	T.B.D.	-	T.B.D.	-	SWING	
113	-	18"	6'-8"	MASONITE	T.B.D.	-	T.B.D.	-	SWING	
114	-	32"	6'-8"	MASONITE	T.B.D.	-	T.B.D.	-	SWING	
115	-	32"	6'-8"	MASONITE	T.B.D.	-	T.B.D.	-	POCKET	
116	YES	60"	6'-8"	MASONITE	T.B.D.	-	T.B.D.	-	FRENCH	
117	-	72"	6'-8"	VINYL	T.B.D.	TEMP	ANDERSEN	LOW-E	SLIDING	
118	-	72"	6'-8"	VINYL	T.B.D.	TEMP	ANDERSEN	LOW-E	SLIDING	
201	-	72"	6'-8"	VINYL	T.B.D.	TEMP	ANDERSEN	LOW-E	SLIDING	
202	-	24"	6'-8"	MASONITE	T.B.D.	-	T.B.D.	-	SWING	
203	-	32"	6'-8"	MASONITE	T.B.D.	-	T.B.D.	-	SWING	
204	-	24"	6'-8"	MASONITE	T.B.D.	-	T.B.D.	-	SWING	LOUVERED
205	-	36"	6'-8"	MASONITE	T.B.D.	-	T.B.D.	-	SWING	1 HOUR FIRE RATED
206	-	32"	6'-8"	MASONITE	T.B.D.	-	T.B.D.	-	SWING	
207	-	32"	6'-8"	MASONITE	T.B.D.	-	T.B.D.	-	SWING	
208	YES	36"	6'-8"	MASONITE	T.B.D.	-	T.B.D.	-	FRENCH	
209	-	32"	6'-8"	MASONITE	T.B.D.	-	T.B.D.	-	SWING	
210	-	30"	6'-8"	MASONITE	T.B.D.	-	T.B.D.	-	SWING	
211	-	32"	6'-8"	MASONITE	T.B.D.	-	T.B.D.	-	SWING	
212	-	30"	6'-8"	MASONITE	T.B.D.	-	T.B.D.	-	SWING	
213	-	18"	6'-8"	MASONITE	T.B.D.	-	T.B.D.	-	SWING	
214	-	32"	6'-8"	MASONITE	T.B.D.	-	T.B.D.	-	SWING	
215	-	32"	6'-8"	MASONITE	T.B.D.	-	T.B.D.	-	POCKET	
216	YES	60"	6'-8"	MASONITE	T.B.D.	-	T.B.D.	-	FRENCH	
217	-	72"	6'-8"	VINYL	T.B.D.	TEMP	ANDERSEN	LOW-E	SLIDING	
218	-	72"	6'-8"	VINYL	T.B.D.	TEMP	ANDERSEN	LOW-E	SLIDING	
301	-	72"	6'-8"	VINYL	T.B.D.	TEMP	ANDERSEN	LOW-E	SLIDING	
302	-	36"	6'-8"	MASONITE	T.B.D.	-	T.B.D.	-	SWING	1 HOUR FIRE RATED
303	YES	48"	6'-8"	MASONITE	T.B.D.	-	T.B.D.	-	SWING	
304	-	32"	6'-8"	MASONITE	T.B.D.	-	T.B.D.	-	SWING	
305	-	30"	6'-8"	MASONITE	T.B.D.	-	T.B.D.	-	POCKET	
206	-	32"	6'-8"	MASONITE	T.B.D.	-	T.B.D.	-	SWING	
207	-	36"	6'-8"	MASONITE	T.B.D.	-	T.B.D.	-	SWING	1 HOUR FIRE RATED

GENERAL DOOR NOTES:
1. GENERAL CONTRACTOR TO SUBMIT A DOOR AND WINDOW ORDER SCHEDULE TO ARCHITECT FOR FINAL CONFIRMATION PRIOR TO ORDERING.
2. CONTACT ARCHITECT IMMEDIATELY IF ANY DISCREPANCIES ARE IDENTIFIED.
3. PROVIDE SCREENS AT SLIDERS
4. DOOR HARDWARE SHALL BE BUILDER STANDARD. REVIEW FINAL SELECTION W/ OWNER
5. REFER TO DETAILS ON SHEET A6.02 FOR TYPICAL FLASHING DETAILS

WINDOW SCHEDULE:										
NO.	WIDTH	HEIGHT	MATERIAL	FINISH	GLASS	MFR.	HEAD	TINT	OPERATION	REMARKS
01	24"	24"	VINYL	T.B.D.	DBL PANE	VIWINCO	6'-8"	LOW-E	AWNING	
101	36"	60"	VINYL	T.B.D.	DBL PANE	VIWINCO	6'-8"	LOW-E	DBL HUNG	
102	36"	60"	VINYL	T.B.D.	DBL PANE	VIWINCO	6'-8"	LOW-E	DBL HUNG	TEMPERED
103	36"	36"	VINYL	T.B.D.	DBL PANE	VIWINCO	6'-8"	LOW-E	AWNING	
104	36"	36"	VINYL	T.B.D.	DBL PANE	VIWINCO	6'-8"	LOW-E	AWNING	
105	36"	60"	VINYL	T.B.D.	DBL PANE	VIWINCO	6'-8"	LOW-E	DBL HUNG	
106	36"	44"	VINYL	T.B.D.	DBL PANE	VIWINCO	6'-8"	LOW-E	DBL HUNG	TEMPERED
107	40"	60"	VINYL	T.B.D.	DBL PANE	VIWINCO	6'-8"	LOW-E	DBL HUNG	EGRESS WINDOW
108	36"	24"	VINYL	T.B.D.	DBL PANE	VIWINCO	6'-8"	LOW-E	AWNING	TEMPERED
109	36"	24"	VINYL	T.B.D.	DBL PANE	VIWINCO	6'-8"	LOW-E	AWNING	TEMPERED
110	36"	44"	VINYL	T.B.D.	DBL PANE	VIWINCO	6'-8"	LOW-E	DBL HUNG	
111	36"	44"	VINYL	T.B.D.	DBL PANE	VIWINCO	6'-8"	LOW-E	DBL HUNG	
112	36"	24"	VINYL	T.B.D.	DBL PANE	VIWINCO	6'-8"	LOW-E	AWNING	
113	36"	24"	VINYL	T.B.D.	DBL PANE	VIWINCO	6'-8"	LOW-E	AWNING	
114	40"	60"	VINYL	T.B.D.	DBL PANE	VIWINCO	6'-8"	LOW-E	DBL HUNG	EGRESS WINDOW TEMPERED
115	36"	44"	VINYL	T.B.D.	DBL PANE	VIWINCO	6'-8"	LOW-E	DBL HUNG	TEMPERED
116	36"	60"	VINYL	T.B.D.	DBL PANE	VIWINCO	6'-8"	LOW-E	DBL HUNG	
117	36"	60"	VINYL	T.B.D.	DBL PANE	VIWINCO	6'-8"	LOW-E	DBL HUNG	
201	36"	60"	VINYL	T.B.D.	DBL PANE	VIWINCO	6'-8"	LOW-E	DBL HUNG	
202	36"	60"	VINYL	T.B.D.	DBL PANE	VIWINCO	6'-8"	LOW-E	DBL HUNG	TEMPERED
203	36"	36"	VINYL	T.B.D.	DBL PANE	VIWINCO	6'-8"	LOW-E	AWNING	
204	36"	36"	VINYL	T.B.D.	DBL PANE	VIWINCO	6'-8"	LOW-E	AWNING	
205	36"	60"	VINYL	T.B.D.	DBL PANE	VIWINCO	6'-8"	LOW-E	DBL HUNG	
206	36"	44"	VINYL	T.B.D.	DBL PANE	VIWINCO	6'-8"	LOW-E	DBL HUNG	TEMPERED
207	40"	60"	VINYL	T.B.D.	DBL PANE	VIWINCO	6'-8"	LOW-E	DBL HUNG	EGRESS WINDOW
208	36"	24"	VINYL	T.B.D.	DBL PANE	VIWINCO	6'-8"	LOW-E	AWNING	TEMPERED
209	36"	24"	VINYL	T.B.D.	DBL PANE	VIWINCO	6'-8"	LOW-E	AWNING	TEMPERED
210	36"	44"	VINYL	T.B.D.	DBL PANE	VIWINCO	6'-8"	LOW-E	DBL HUNG	

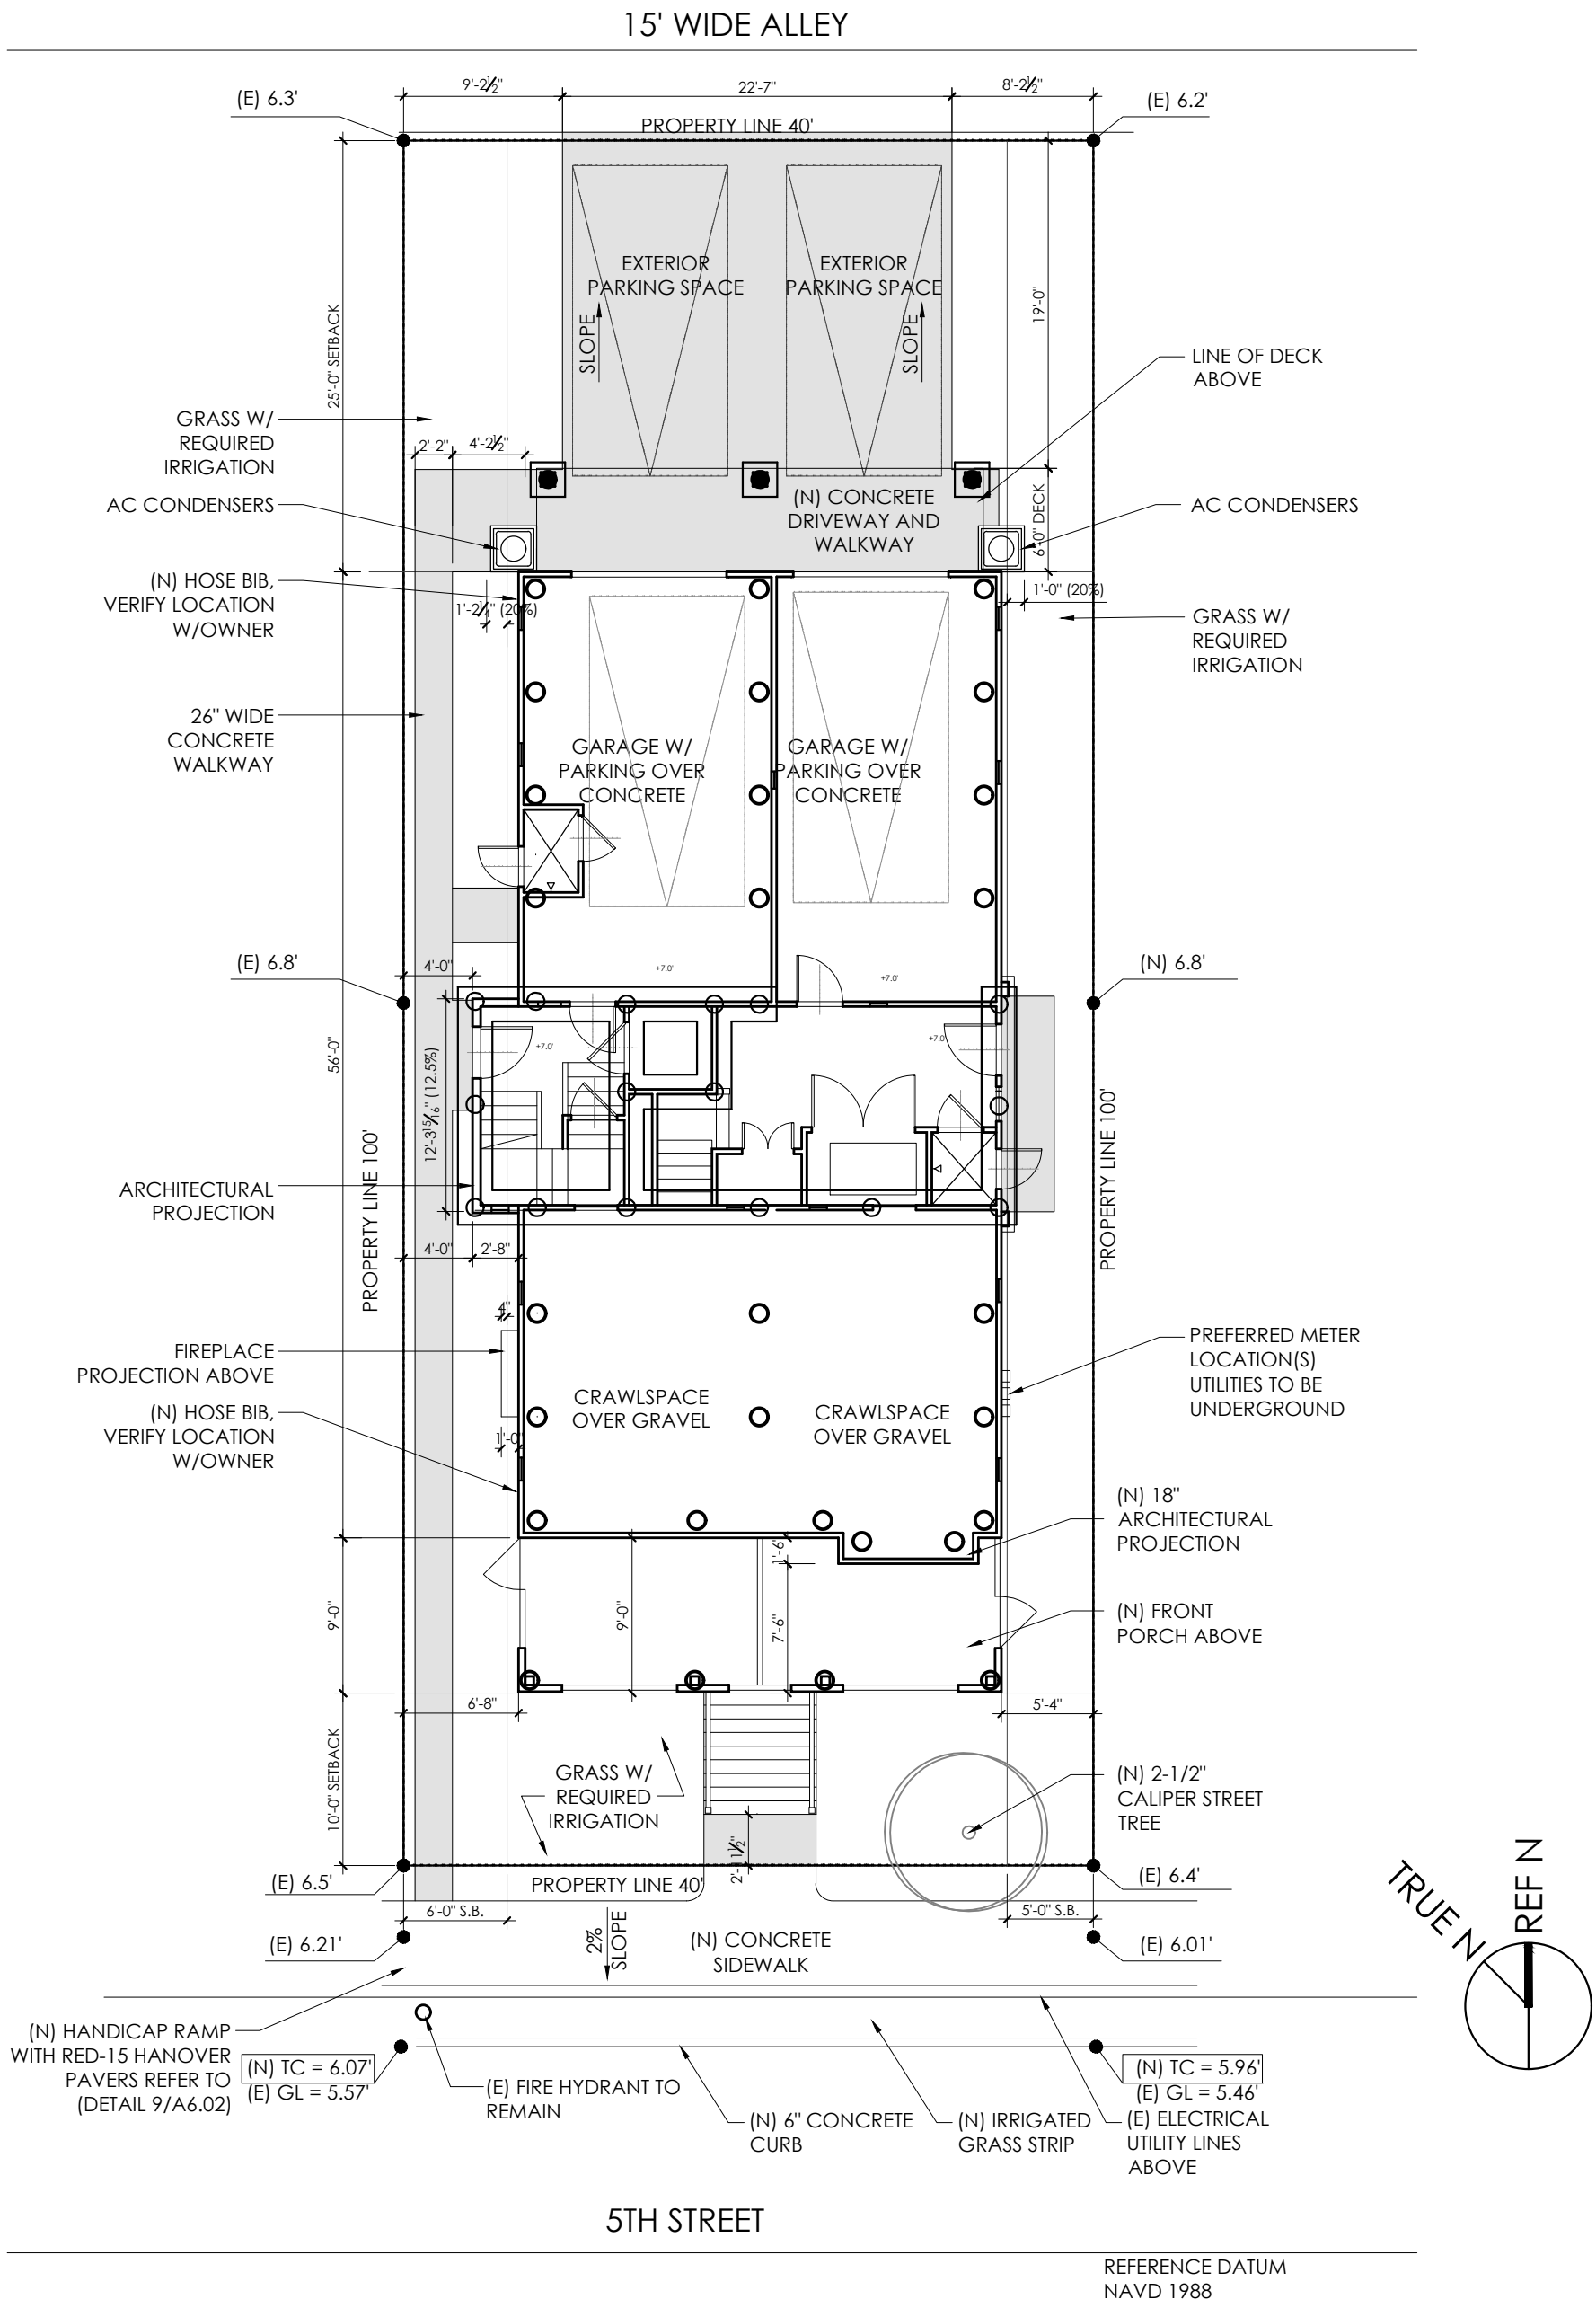

SITE PLAN

WINDOW SCHEDULE (CONTINUED):

SCALE: 1"=10'

WIDTH	HEIGHT	MATERIAL	FINISH	GLASS	MFR.	HEAD	TINT	OPERATION	REMARKS
36"	44"	VINYL	T.B.D.	DBL PANE	VIWINCO	6'-8"	LOW-E	DBL HUNG	
36"	24"	VINYL	T.B.D.	DBL PANE	VIWINCO	6'-8"	LOW-E	AWNING	
36"	24"	VINYL	T.B.D.	DBL PANE	VIWINCO	6'-8"	LOW-E	AWNING	
40"	60"	VINYL	T.B.D.	DBL PANE	VIWINCO	6'-8"	LOW-E	DBL HUNG	EGRESS WINDOW
36"	44"	VINYL	T.B.D.	DBL PANE	VIWINCO	6'-8"	LOW-E	DBL HUNG	TEMPERED
36"	60"	VINYL	T.B.D.	DBL PANE	VIWINCO	6'-8"	LOW-E	DBL HUNG	
36"	60"	VINYL	T.B.D.	DBL PANE	VIWINCO	6'-8"	LOW-E	DBL HUNG	
36"	24"	VINYL	T.B.D.	DBL PANE	VIWINCO	6'-8"	LOW-E	AWNING	
36"	24"	VINYL	T.B.D.	DBL PANE	VIWINCO	6'-8"	LOW-E	AWNING	
36"	24"	VINYL	T.B.D.	DBL PANE	VIWINCO	6'-8"	LOW-E	AWNING	TEMPERED
36"	24"	VINYL	T.B.D.	DBL PANE	VIWINCO	6'-8"	LOW-E	AWNING	
36"	24"	VINYL	T.B.D.	DBL PANE	VIWINCO	6'-8"	LOW-E	AWNING	
36"	48"	VINYL	T.B.D.	DBL PANE	VIWINCO	6'-8"	LOW-E	DBL HUNG	
36"	48"	VINYL	T.B.D.	DBL PANE	VIWINCO	6'-8"	LOW-E	DBL HUNG	
40"	60"	VINYL	T.B.D.	DBL PANE	VIWINCO	6'-8"	LOW-E	DBL HUNG	EGRESS WINDOW
40"	60"	VINYL	T.B.D.	DBL PANE	VIWINCO	6'-8"	LOW-E	DBL HUNG	EGRESS WINDOW
36"	44"	VINYL	T.B.D.	DBL PANE	VIWINCO	6'-8"	LOW-E	DBL HUNG	TEMPERED
36"	24"	VINYL	T.B.D.	DBL PANE	VIWINCO	6'-8"	LOW-E	AWNING	

CONSTRUCTION NOTES

1. FLOOD VENT REQUIREMENTS: 1" OF FLOOD VENT PER S.F. ("SMART VENT" MODEL #1540-570 FLOOD VENTS, 8 1/2"X14 1/2", PROVIDING COVERAGE FOR 200 SQUARE FEET).

Garage/ Foyer: 1035 S.F. (6 VENT REQUIRED/ 6 VENTS PROVIDED)
Crawlspace: 532 S.F. (3 VENTS REQUIRED/ 3 VENTS PROVIDED)

2. INSULATION REQUIRED AT FLOOR/CEILING, AND ALL EXTERIOR WALLS PER RES-CHECK DOCUMENT:
WOOD FLOOR: R-30
CEILING: R-30
EXTERIOR WALLS: R-19

3. ALL EXTERIOR WALLS AND OVERHANGS WITHIN 5'-0" OF OF THE SIDE YARD SETBACKS TO HAVE 1 HR FIRE RATING WITH EXTERIOR GRADE TYPE "X" DRYWALL ON THE OUTSIDE OF THE SHEATHING AND TYPICAL TYPE "X" INTERIOR DRYWALL WHERE APPLICABLE (SEE PARTITION DETAIL).

4. G.C. IS TO REFER TO NOTES/ DETAILS ON SHEETS A6.01 FOR STRUCTURAL LOADS AND CONNECTION INFORMATION.

5. STAIR WELLS ARE TO BE CONSTRUCTED WITH 1 HOUR FIRE RATED WALLS (TYPICAL)

6. ALL WINDOWS IN STAIRWELLS AND WITHIN 60" OF PLUMBING HORIZONTALLY AND 36" VERTICALLY ARE TO BE TEMPERED.

7. ALL LUMBER LOCATED BELOW THE D.F.E. SHALL BE PRESSURE TREATED. ALL SHEATHING BELOW THE D.F.E. SHALL BE WATER RESISTANT PLYWOOD. ALL INTERIOR SHEATHING BELOW D.F.E. SHALL BE WATER RESISTANT FIBER CEMENT BOARDS. ALL INSULATION BELOW D.F.E. SHALL BE CLOSED CELL WATER RESISTANT/ MOLD RESISTANT INSULATION.

8. HOME IS TO BE CONSTRUCTED WITH ONE LEVEL FOR PARKING, LIMITED STORAGE AND BUILDING ACCESS AND TWO LEVELS OF LIVING ABOVE. UNDER THE SEPTEMBER 4, 2013 "GRADE LEVEL FLOOD ELEVATION MEMO," THIS STRUCTURE COMPLIES WITH THE V8 CONSTRUCTION TYPE DEFINITION.

9. APPLIANCES AND GAS FIREPLACES ARE TO BE INSTALLED TO MEET MANUFACTURERS AND CODE REQUIREMENTS (WHICHEVER IS MORE STRINGENT).

ELECTRICAL NOTES

1. ALL ELECTRICAL WORK TO CONFORM WITH THE 2017 NATIONAL ELECTRICAL CODE'S LATEST REVISION.

2. ELECTRICAL CONTRACTOR SHALL VERIFY AND CHECK ALL CONDITION AND EQUIPMENT PRIOR TO BEGINNING WORK AND REPORT ANY DISCREPANCIES.

3. ELECTRICAL CONTRACTOR SHALL COORDINATE HIS WORK WITH THE ATLANTIC CITY ELECTRIC COMPANY AND SHALL COOPERATE WITH THEM IN DETERMINING LOADS, HOOKUPS, TEMPORARY SERVICES, ECT.

4. CONTRACTOR SHALL PROVIDE SMOKE DETECTORS OR APPROVED DESIGN IN EACH LEVEL IN LOCATION AS RECOMMENDED BY THE MANUFACTURER AND/ OR AS SHOWN ON THE PLANS. SMOKE DETECTORS TO BE WIRED SO THE SIGNAL IS RELAYED TO ALL LOCATIONS.

5. ALL WIRE SHALL BE A MINIMUM NO 12. AWG TYPE THW COPPER RATED AT 75 DEGREES C. AND 147 DEGREES F. CONTRACTOR TO PROVIDE CONDUIT WHERE REQUIRED BY MEC (MIN 1/2" CONDUIT). HOME RUN CIRCUITS MORE THAN 75' FROM PANEL BOARD SHALL BE NO. 10 AWG OR LARGER AS REQUIRED.

6. ALL BATH AND POWDER ROOM OUTLETS SHALL BE GROUND FAULT CIRCUIT INTERRUPT TYPE. EXTERIOR OUTLETS SHALL BE GROUND FAULT CIRCUIT INTERRUPT TYPE AND WEATHERPROOF.

7. WHERE SWITCHES, RECEPTACLES AND OTHER OUTLETS ARE SHOWN BACK TO BACK IN INTERIOR PARTITIONS, THEY SHALL BE STAGGERED TO PREVENT THE TRANSMISSION OF SOUND THROUGH THE PARTITION. WHEN OUTLETS ARE BACK TO BACK IN A FIRE RATED WALL ASSEMBLY, LOCATE EACH OUTLET IN A SEPARATE AND ADJACENT STUD TO AVOID OPENINGS IN BOTH FACES OF FIRE RATED WALL IN A SINGLE STUD FACE (ALWAYS FOLLOW FIRE RATED PARTITION ASSEMBLY GUIDELINES)

8. DO NOT SCALE DRAWINGS. VERIFY LOCATION OF EQUIPMENT AND FIXTURES ON THE JOB SITE WITH THE GENERAL CONTRACTOR, ARCHITECT AND OTHER TRADES.

9. CIRCUIT THE LIGHTING AND RECEPTACLES ON DIFFERENT CIRCUITS SO THAT EACH SPACE CONTAINS PARTS OF AT LEAST TWO CIRCUITS.

10. PROVIDE A MAXIMUM OF 8 CONVENIENCE ON ANY ONE 20 AMP CIRCUIT, MAXIMUM 7 ON ANY 15 AMP CIRCUIT AND MAXIMUM 2 KITCHEN APPLIANCE RECEPTACLES ON ANY 20 AMP CIRCUIT.

11. CABLE TELEVISION, CATS AND TELEPHONE OUTLETS SHALL BE PREWIRED DURING CONSTRUCTION WITH WALL OUTLETS.

12. ALL LIGHT FIXTURE SELECTIONS AND FINAL LOCATIONS TO BE SELECTED AND APPROVED BY OWNER/ ARCHITECT.

13. ALL RECESSED LIGHTS SHALL BE RATED FOR INSULATION CONTACT.



14. ELECTRICAL CONTRACTOR TO PROVIDE POWER AT HWH AND HVAC EQUIPMENT PER EQUIPMENT MANUFACTURERS GUIDELINES.

16. ALL SMOKE DETECTORS ARE TO BE HARDWIRED 110V

PROJECT DATA	
Agent	861-867 Fifth St. LLC
Project address:	861-63 5th Street Ocean City, NJ 08226
Code:	2018 International Residential Code, New Jersey Edition R-5
Use Group:	VA
Construction Type:	A
Flood Zone:	9'-0" BFE
Base Flood Elevation:	11'-0"
DPE	11'-0"
Zoning Flood Elevation:	12'-0" Z.F.E.
Average Grade Calc:	6.25'+6.25'+6.3'+6.3'=25.1'/4=6.275' average
Zone	Corinthian R-2 Neighborhood Zones
Lot	23.01
Block	403
Elevation Height	34' ABOVE 12'-0" Z.F.E.
Lot Square Footage	4,000 sf
Coverage	1,484 / 4,000 = 37% (40% ALLOWED)
Impervious Coverage	2,761 / 4,000 = 69% (65%+5% ALLOWED) Recharge System to be installed
Ground Floor SF	Garage 673 sf Foyer(s) 362 sf Crawlspace 532 sf Ground Fl. Total: 1,567 sf
First Floor SF	Living Area 1,484 sf Covered Patches 439 sf 1st Fl. Total: 1,923 sf
Second Floor SF	Living Area 1,484 sf Decks 439 sf 2nd Fl. Total: 1,923 sf
Attic Floor SF	Living Area 740 sf Decks 250 sf
Attic Half Story:	2nd Fl. Total: 990 sf 50% 740 sf / 1,484 sf (49.8%)
Roof SF	1,838 sf Percentage under 4/12 (0%) Cupola 54 sf / 1,838 sf=3%
Total Building Volume:	Ground Floor: 13,888 cubic feet First Floor: 19,230 cubic feet Second Floor: 19,230 cubic feet Attic: 10,506 cubic feet Total: 62,854 cubic feet

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ARCHITECTURAL DRAWINGS	
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A1.02	Second Floor and Attic Floor Plans
A1.03	Roof Plan
A2.01	Ground + First Floor Reflected Ceiling Plan
A2.02	Second Floor + Attic Reflected Ceiling Plan
A3.01	Front Elevation and Side Elevation
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A6.02	Details
S.1	Ground and First Floor Framing Plan
S.2	Framing Plan

MECHANICAL NOTES:

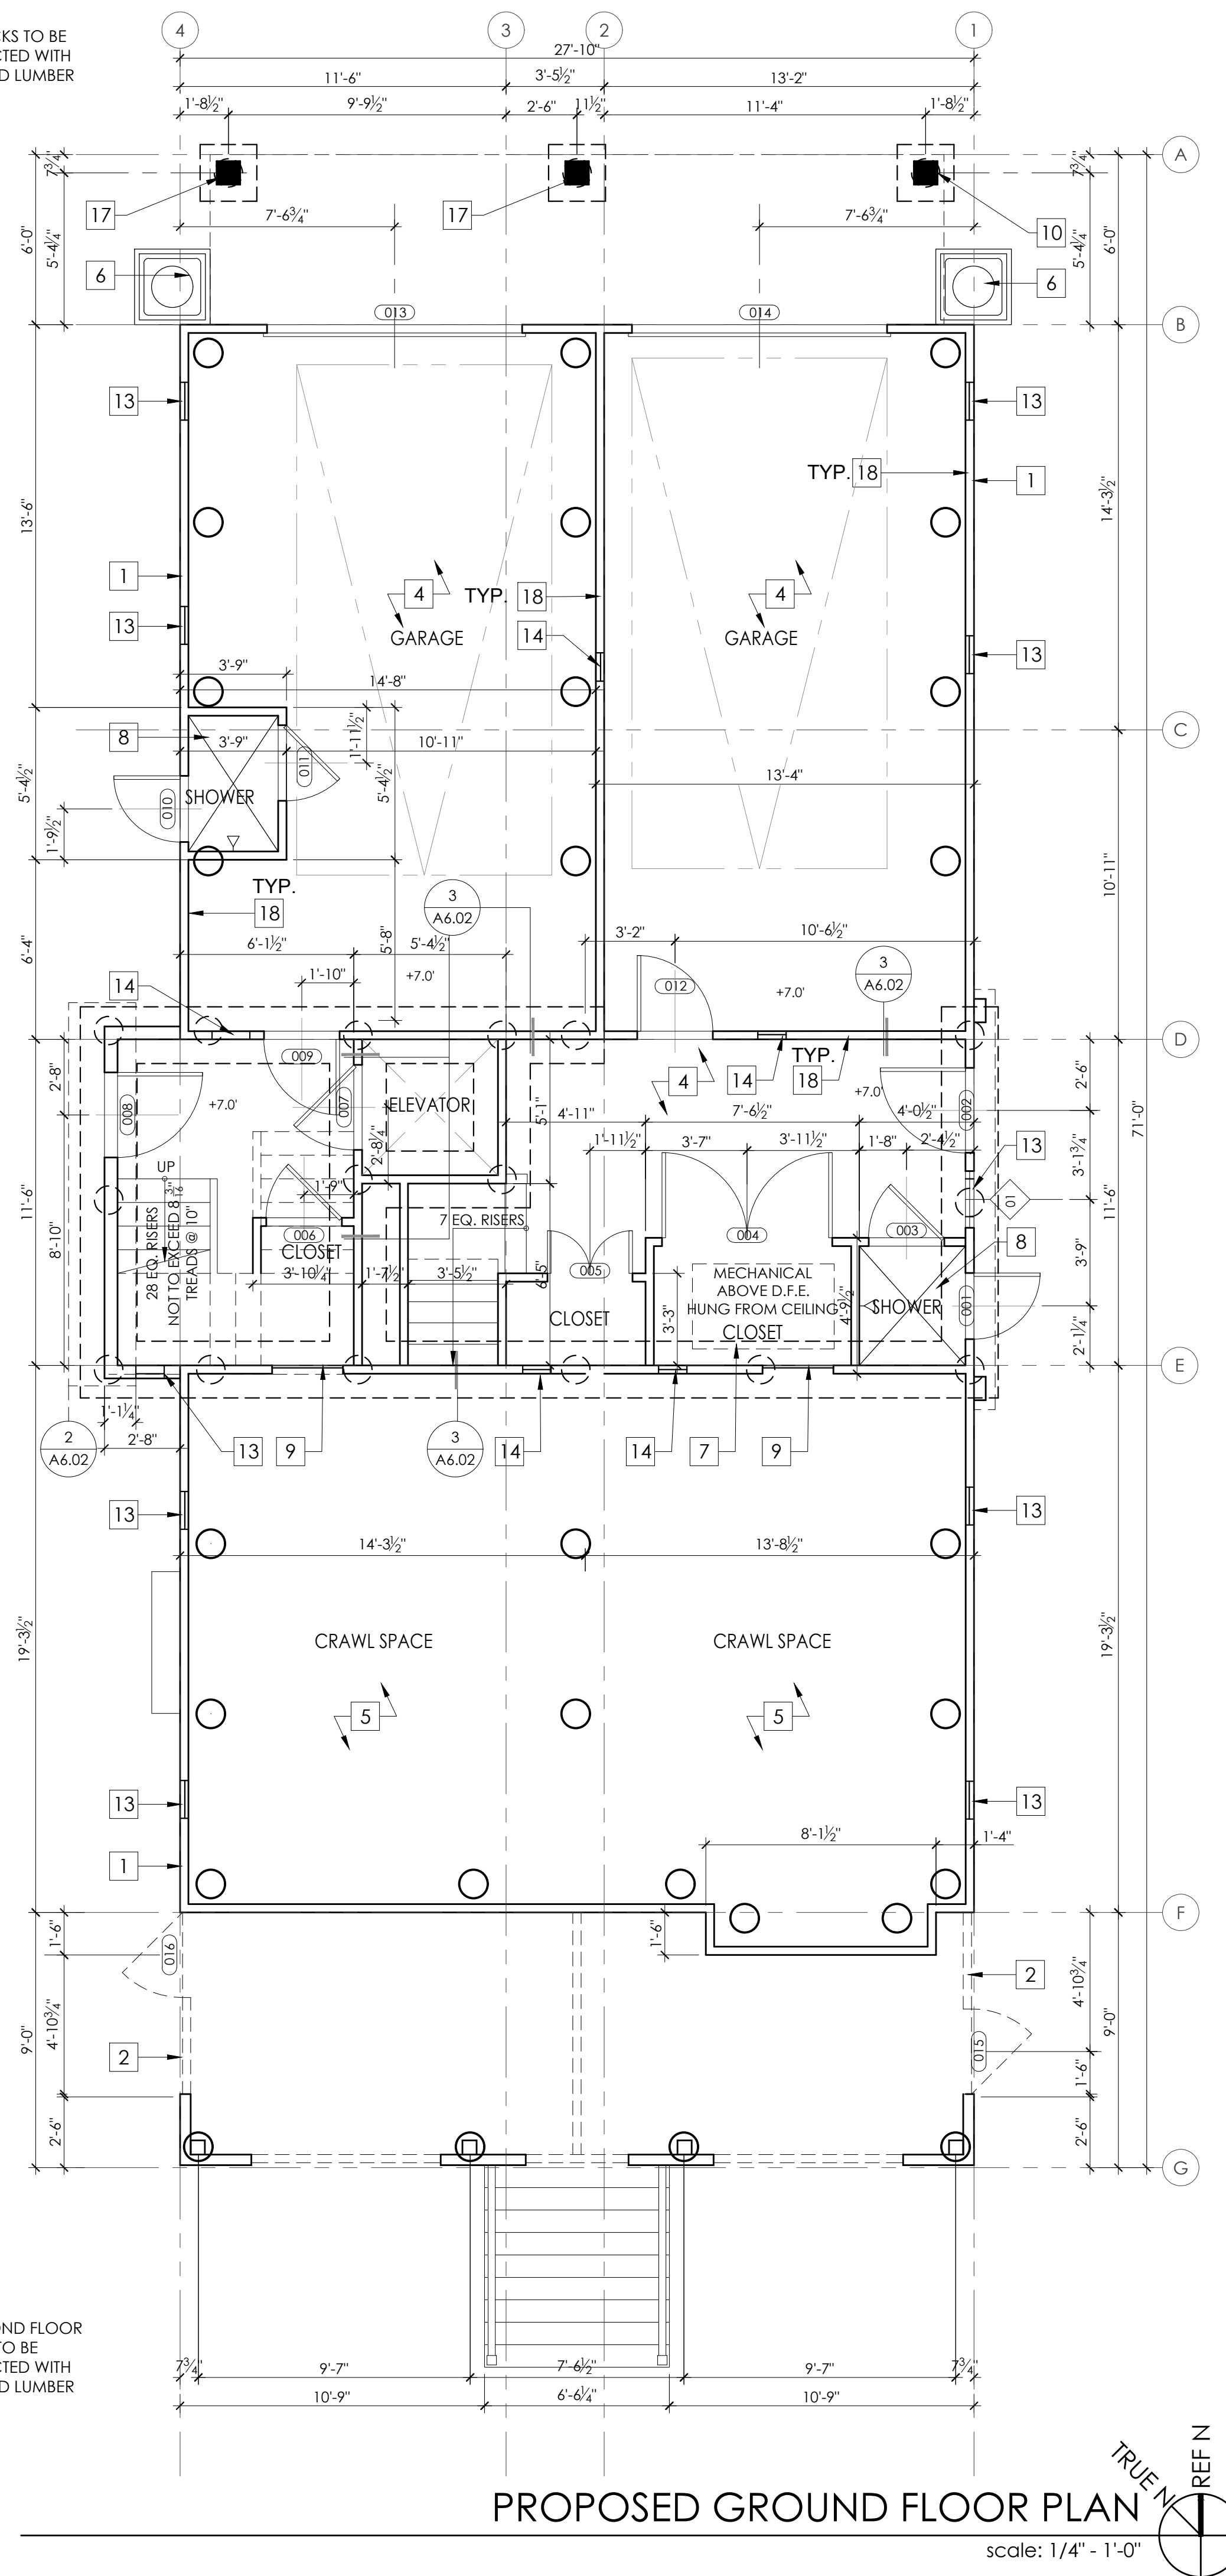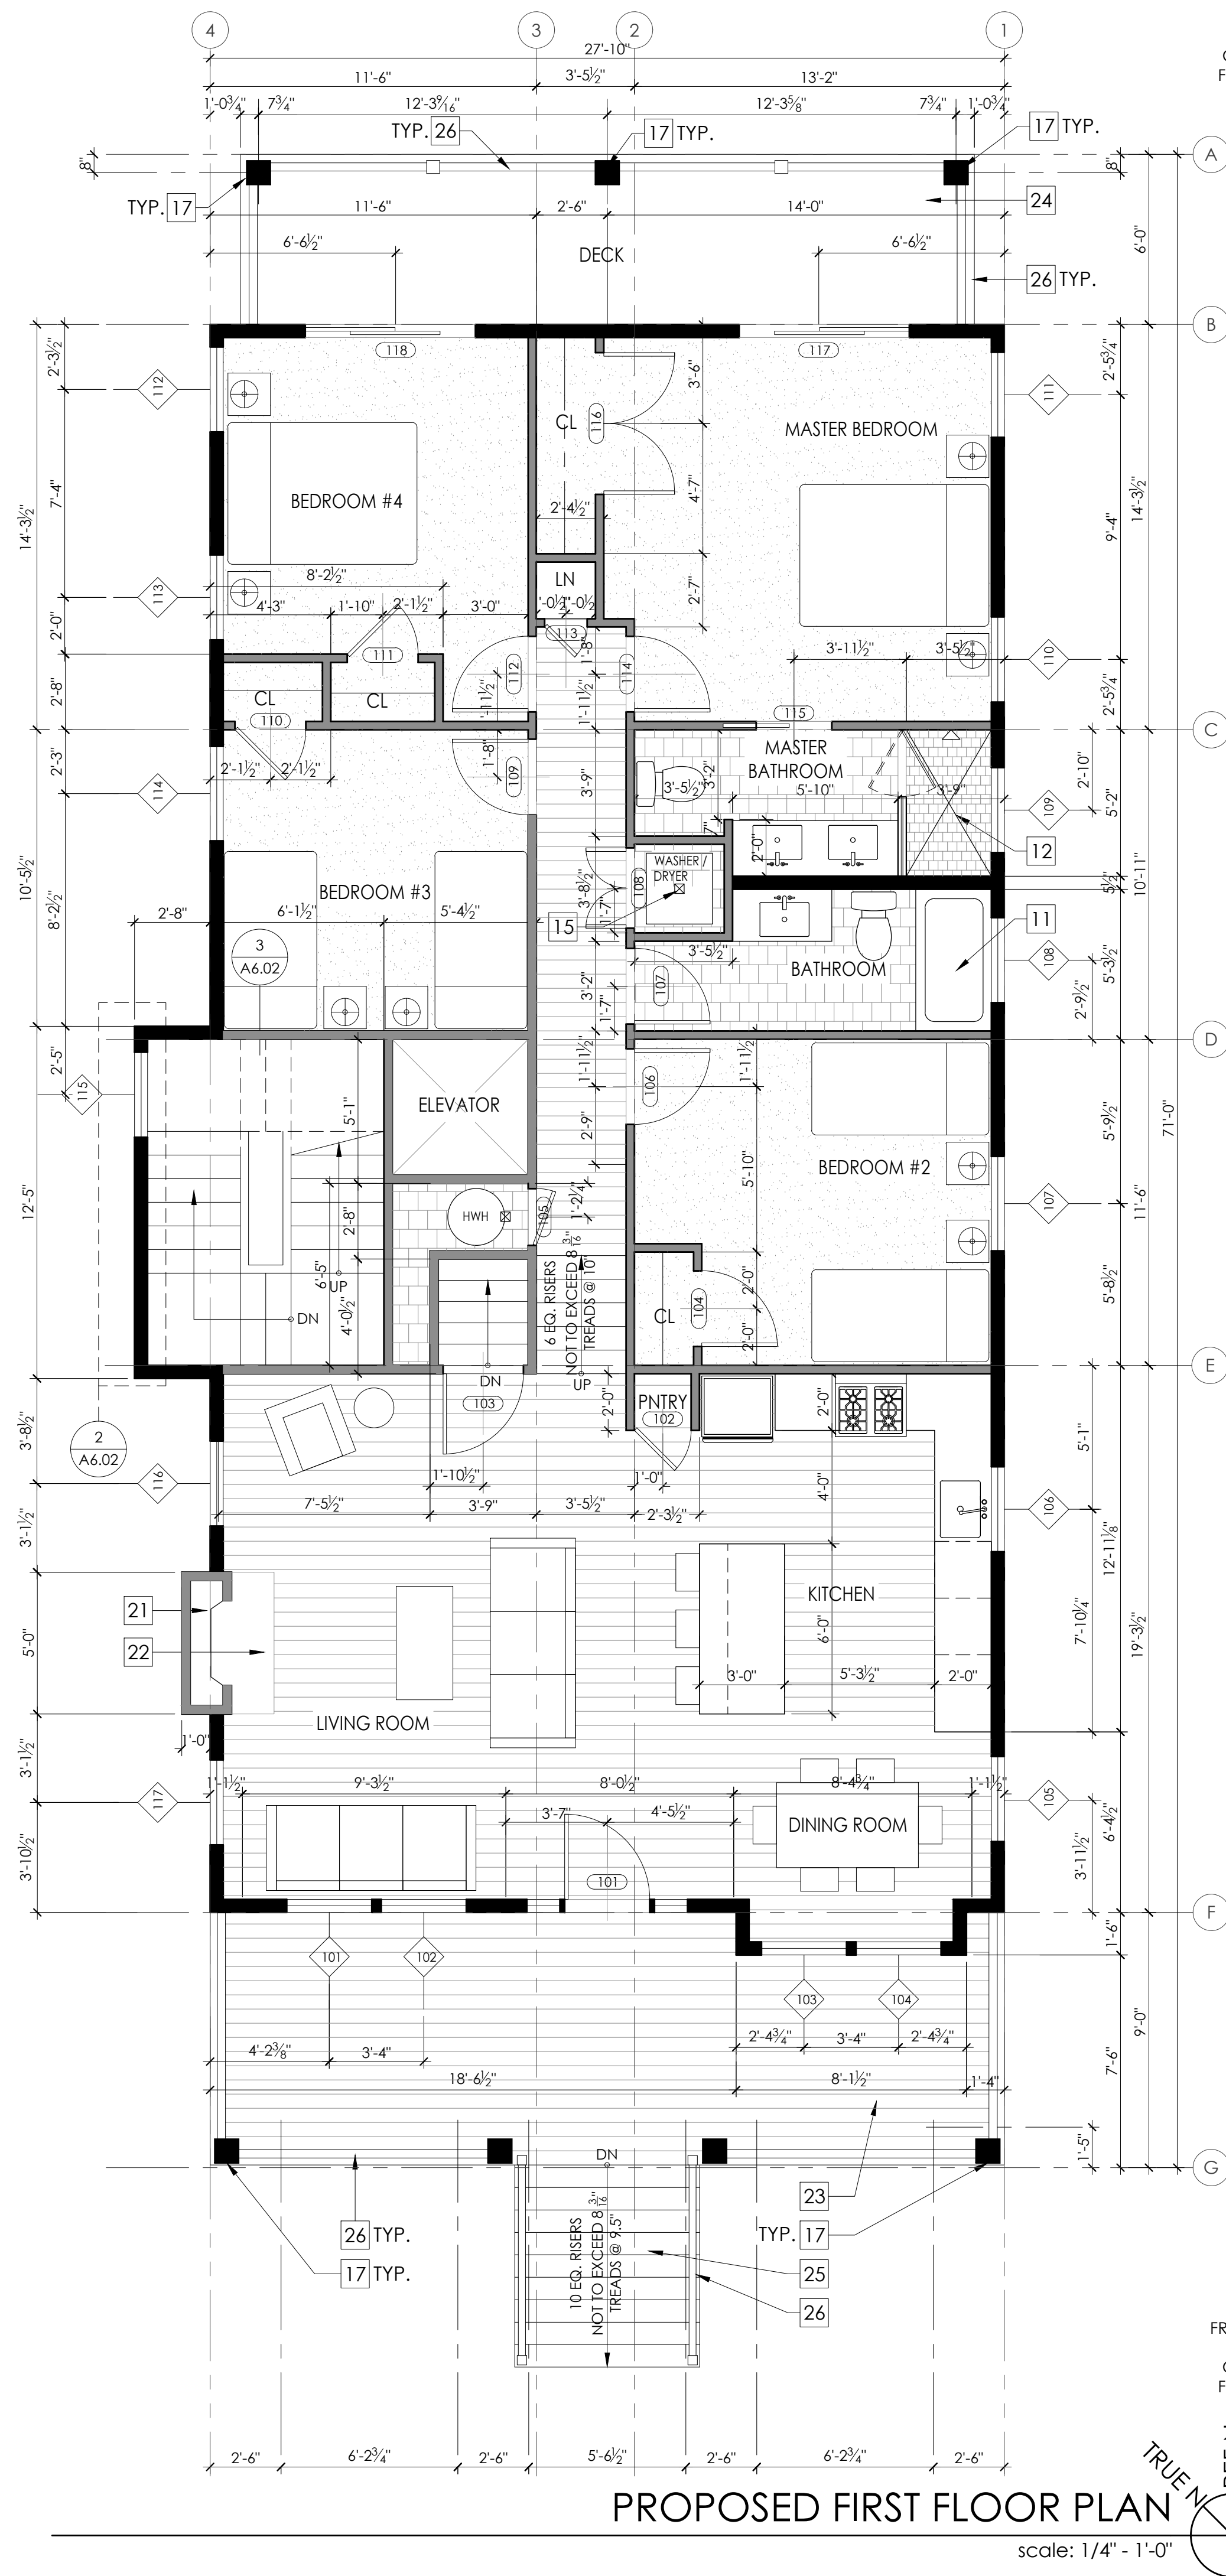

GENERAL NOTES

1. DIMENSIONS ARE TO FACE OF FRAME UNLESS NOTED OTHERWISE.
2. DIMENSIONS WITH "CLR" ARE FINISH DIMENSIONS REQUIRED BY CODE.
3. ALL EXTERIOR WINDOWS AND DOORS ARE TO BE INSTALLED WITH (2) 2X10 BUILT UP STRUCTURAL HEADER BEARING ON 3 1/2" X 3 1/2" DBL JACKS.
4. HURRICANE CLIPS TO BE INSTALLED TO SECURE EACH FLOOR JOISTS (FJ).
5. HURRICANE CLIPS TO BE INSTALLED TO SECURE EACH ROOF RAFTER.
6. REFER TO DETAIL SHEETS FOR SHEAR WALL AND NAILING DETAILS.
7. REFER TO CONSTRUCTION NOTES ON A0.01 FOR ADDITIONAL INFORMATION
8. REFER TO STRUCTURAL DRAWINGS FOR FRAMING AND CONNECTIONS DETAILS
9. SEE SHEETS A6.01 AND A6.02 FOR DETAILS
10. REFER TO STRUCTURAL DRAWINGS FOR FRAMING AND CONNECTIONS DETAILS
11. PILING TO BE CLASS B, 10" BUTT 8" HEAD MIN. W/ A CAPACITY OF 12 TONS THROUGHOUT.
12. ALL HEADERS ARE TO BE 2X10'S UNLESS OTHERWISE NOTED.
13. REAR DECKS ARE TO BE CONSTRUCTED W/ FIRE TREATED LUMBER AND TO BE FIRE SPRAYED.

WALL LEGEND

- NOTE: P.T. LUMBER REQUIRED AT ALL LOCATIONS BELOW D.F.E.
- (N) 2X6 EXTERIOR LOAD BEARING WALL. P.T. LUMBER REQUIRED BELOW D.F.E.
 - (N) 2X4 INTERIOR NON LOAD BEARING WALL

KEYNOTES

- 1 (N) SMOOTH TROWELED STUCCO FINISHED WALL AT GARAGE AND CRAWLSPACE. REFER TO EXTERIOR ELEVATIONS.
- 2 (N) VARYING WIDTH 4" AND 6" AZEK BOARD SCREENING UNDER DECK
- 3 (N) CONCRETE SLAB ON GRADE W/ VISUQUIM MESH
- 4 (N) 4" THICK STRUCTURAL CONCRETE SLAB, TO BE POURED ON COMPACTED FILL W/ 6MM VISUQUIM
- 5 (N) GRAVEL
- 6 (N) A.C. CONDENSER UNIT
- 7 (N) HVAC UNIT SUSPENDED FROM CEILING ABOVE
- 8 (N) OUTDOOR SHOWER ENCLOSURE WITH COMPOSITE DECKING FLOOR OVER GRAVEL WITH FRENCH DRAIN
- 9 (N) CRAWLSPACE ACCESS PANEL
- 10 (N) 6"x6" 1 HR FIRE TREATED STRUCTURAL POST WRAPPED WITH AZEK
- 11 (N) 5'-0" FIBERGLASS SHOWER/TUB INSERT
- 12 (N) TILED SHOWER WITH FIBERGLASS PAN AND GLASS DOOR/ENCLOSURE
- 13 FLOOD VENT: "SMART VENT" MODEL #1540-520, 8 1/2"x14 1/2". PROVIDING COVERAGE FOR 200 SQUARE FEET EA.
- 14 (N) INTERIOR SCREEN VENT
- 15 (N) FLOOR DRAIN
- 16 (N) CERTAINTED TRIPLE 5" STRAIGHT EDGE SAWMILL SHINGLES (COLOR TO BE SELECTED BY OWNER)
- 17 (N) 10" SQUARE FLAT FIBERGLASS COLUMN WITH BASE AND CAP PER THE ELEVATIONS, OVER 6"x6" P.T. POST
- 18 (N) WATER RESISTANT GYP. BOARD BELOW Z.F.E. (@ GARAGE AND CRAWL SPACE INTERIOR))
- 19 ASPHALT SHINGLE ROOF. COLOR T.B.D.
- 20 GUTTER/DOWNSPOUT, COLOR T.B.D.
- 21 GAS FIREPLACE TO BE SELECTED BY OWNER
- 22 NON-COMBUSTIBLE FIREPLACE HEARTH
- 23 COMPOSITE DECKING SECURED TO DECK STRUCTURE, SLOPE AWAY FROM HOUSE @ 2% MIN. COLOR T.B.D.
- 24 (N) FIBERGLASS DECK COATING, SLOPE AWAY FROM HOUSE. (FRAMING TO BE TREATED/ DECKING TO BE FIRE SPRAYED)
- 25 (N) EXTERIOR STAIR TO HAVE 4X4 POSTS (WHERE REQUIRED) W/ 2X12 STRINGERS @ 12" O.C.
- 26 STAIR/DECK GUARDRAIL, 36" MIN. WHITE VINYL FINISH
- 27 EXTERIOR WALL SCONCE, REFER TO REFLECTED CEILING / POWER PLANS ON A2.01 + A2.02
- 28 PULL DOWN ATTIC STAIR/LADDER, CONTRACTOR TO COORDINATE WITH OPENING WITH FRAMING
- 29 CERTAINTED 5" SHIPLAP SIDING (COLOR TO BE SELECTED BY OWNER)
- 30 BRICK VENEER OVER PRESSURE TREATED PLYWOOD
- 31 VERTICAL BEADBOARD PVC SHIPLAP CUPOLA WITH STANDING SEAM METAL ROOF
- 32 10" PILLAR COLUMN WITH STANDING SEAM ROOF
- 33 PVC PANNELLING PER ELEVATION
- 34 CERTAINTED BOARD AND BATTEN SIDING (COLOR TO BE SELECTED BY OWNER)



Halliday Architects

Architect: Christopher Halliday
email: chris@hallidayarchitects.com
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Address: P.O. Box 186
Ocean City, NJ 08226

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PROJECT TEAM:

SIGNATURE
CHRISTOPHER HALLIDAY L1821A101936000

SUBMITTAL INFO. / DATE

PROJECT INFORMATION: 2129

DATE: 05.05.2021 DRAWN BY: CMH
PROJECT:

861-63 5th Street
Ocean City, NJ

PROJECT ADDRESS:
861-63 5th Street
Ocean City, NJ
08226

OWNER CONTACT:
861-867 Fifth Street LLC
11 E 9th Street Suite 3
Ocean City NJ, 08226



LOT AND BLOCK: Lot 23.02
Block 403

SHEET NUMBER AND NAME:

A1.01

First + Second
Floor Plans



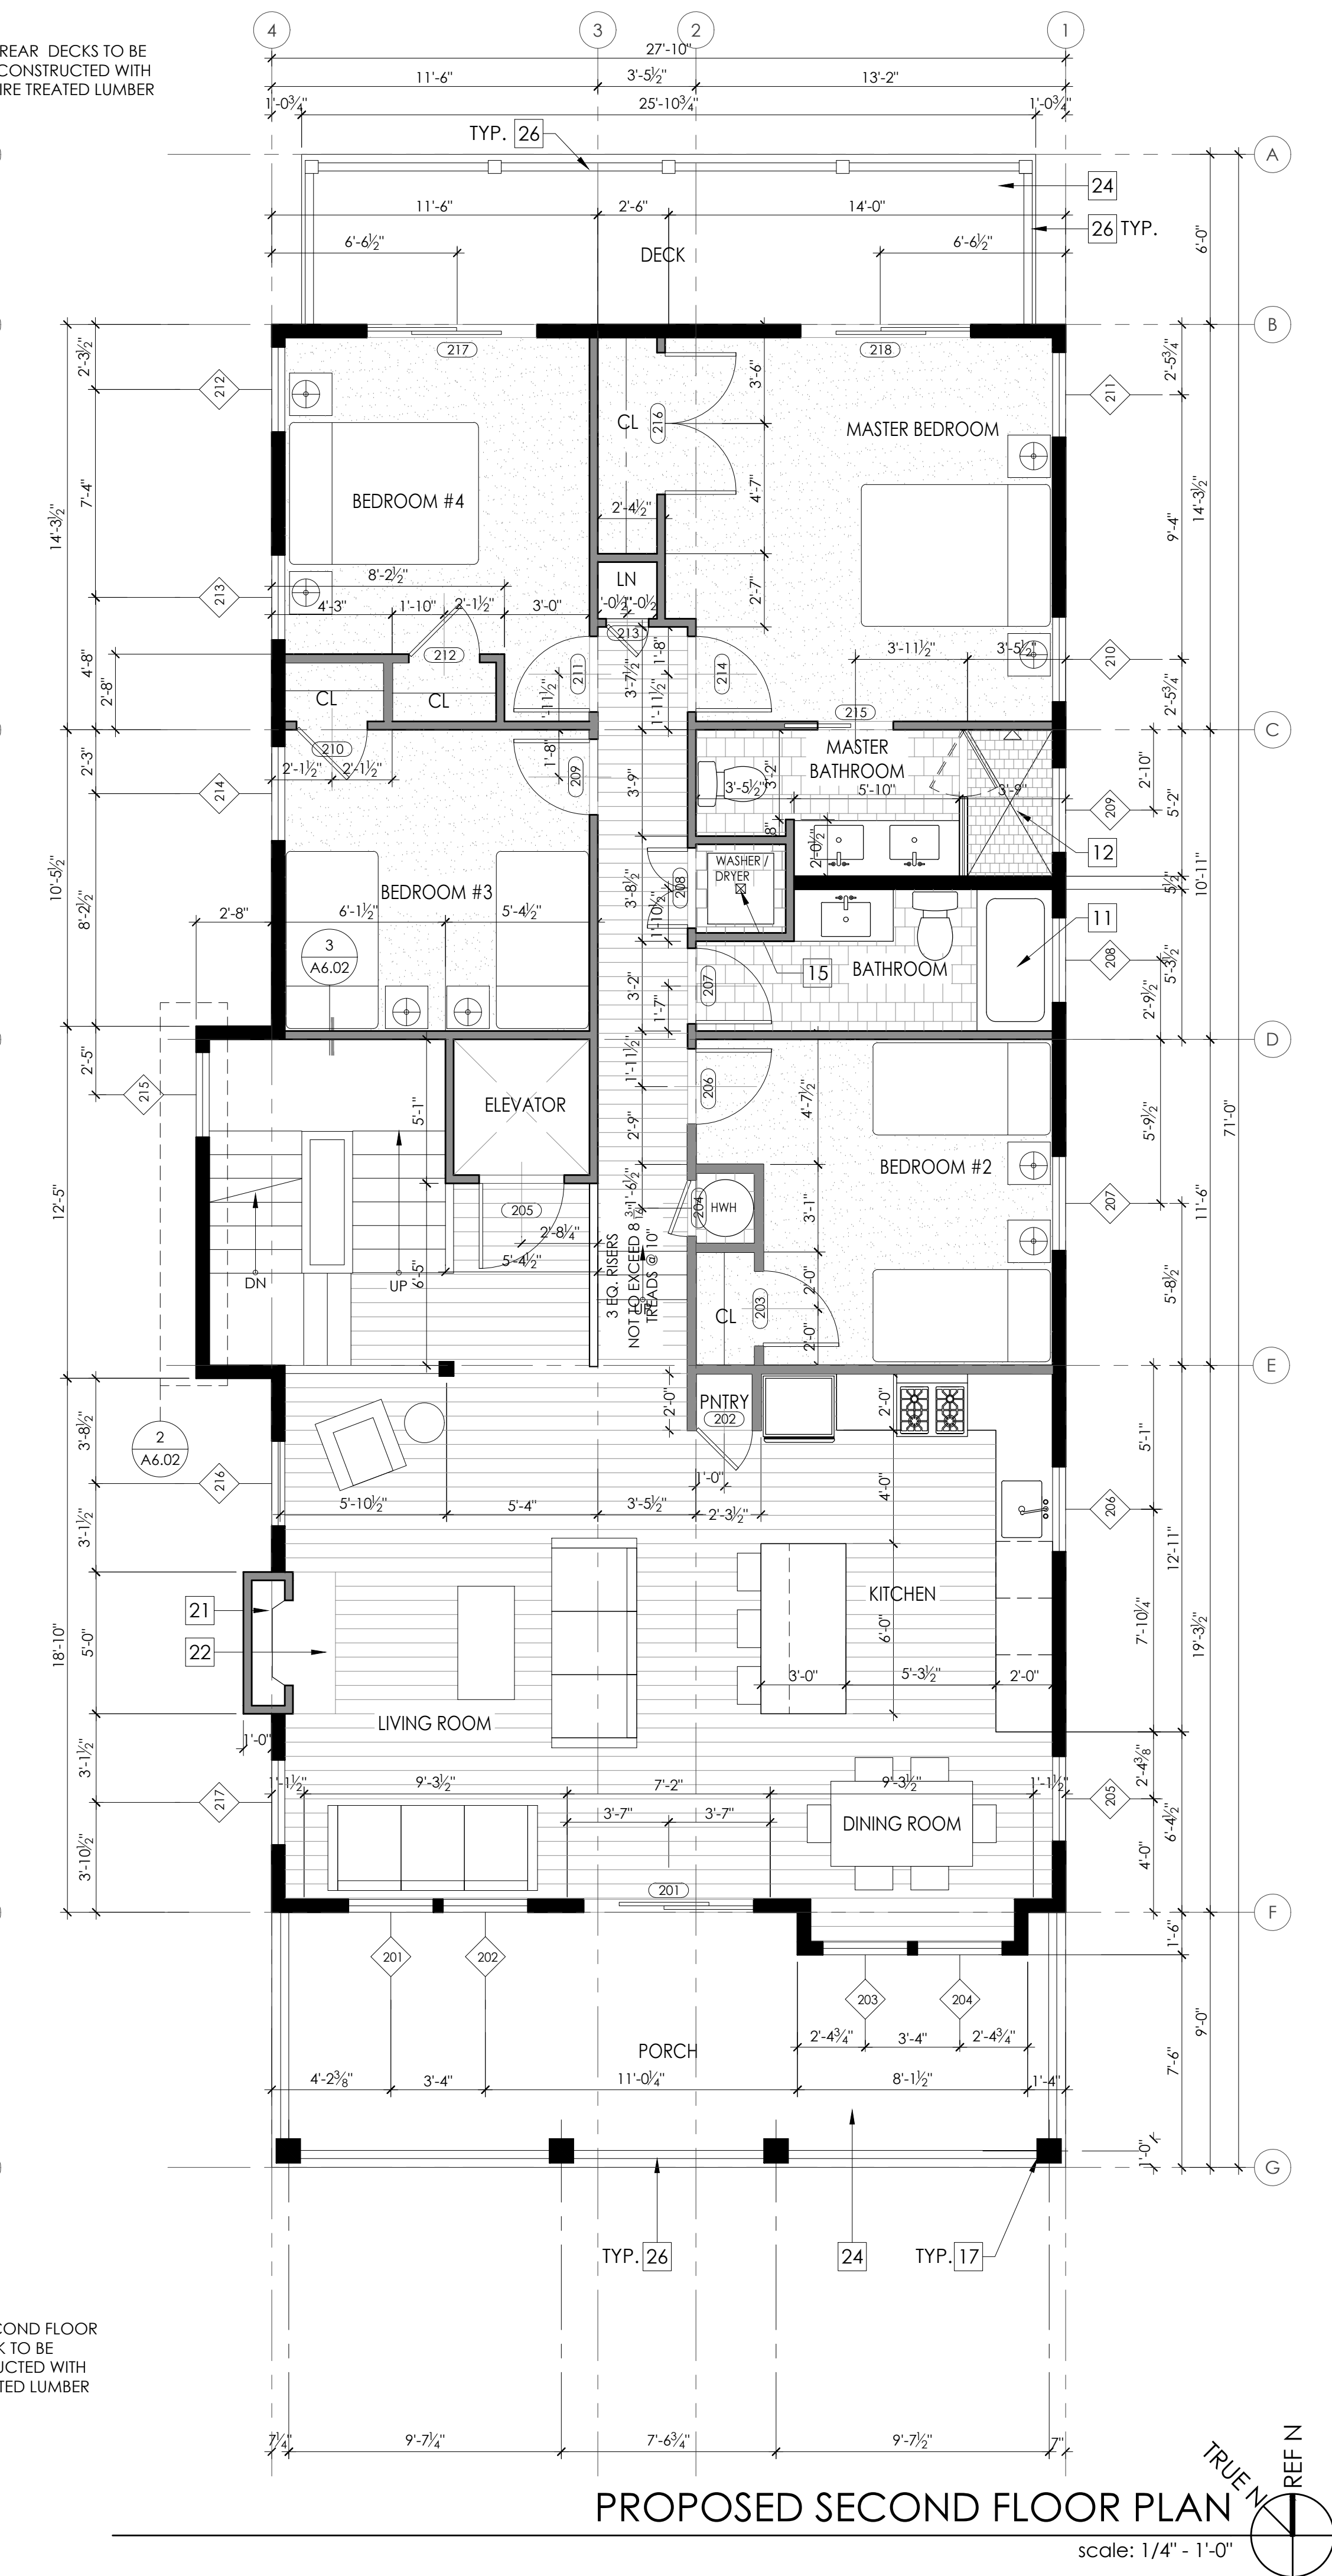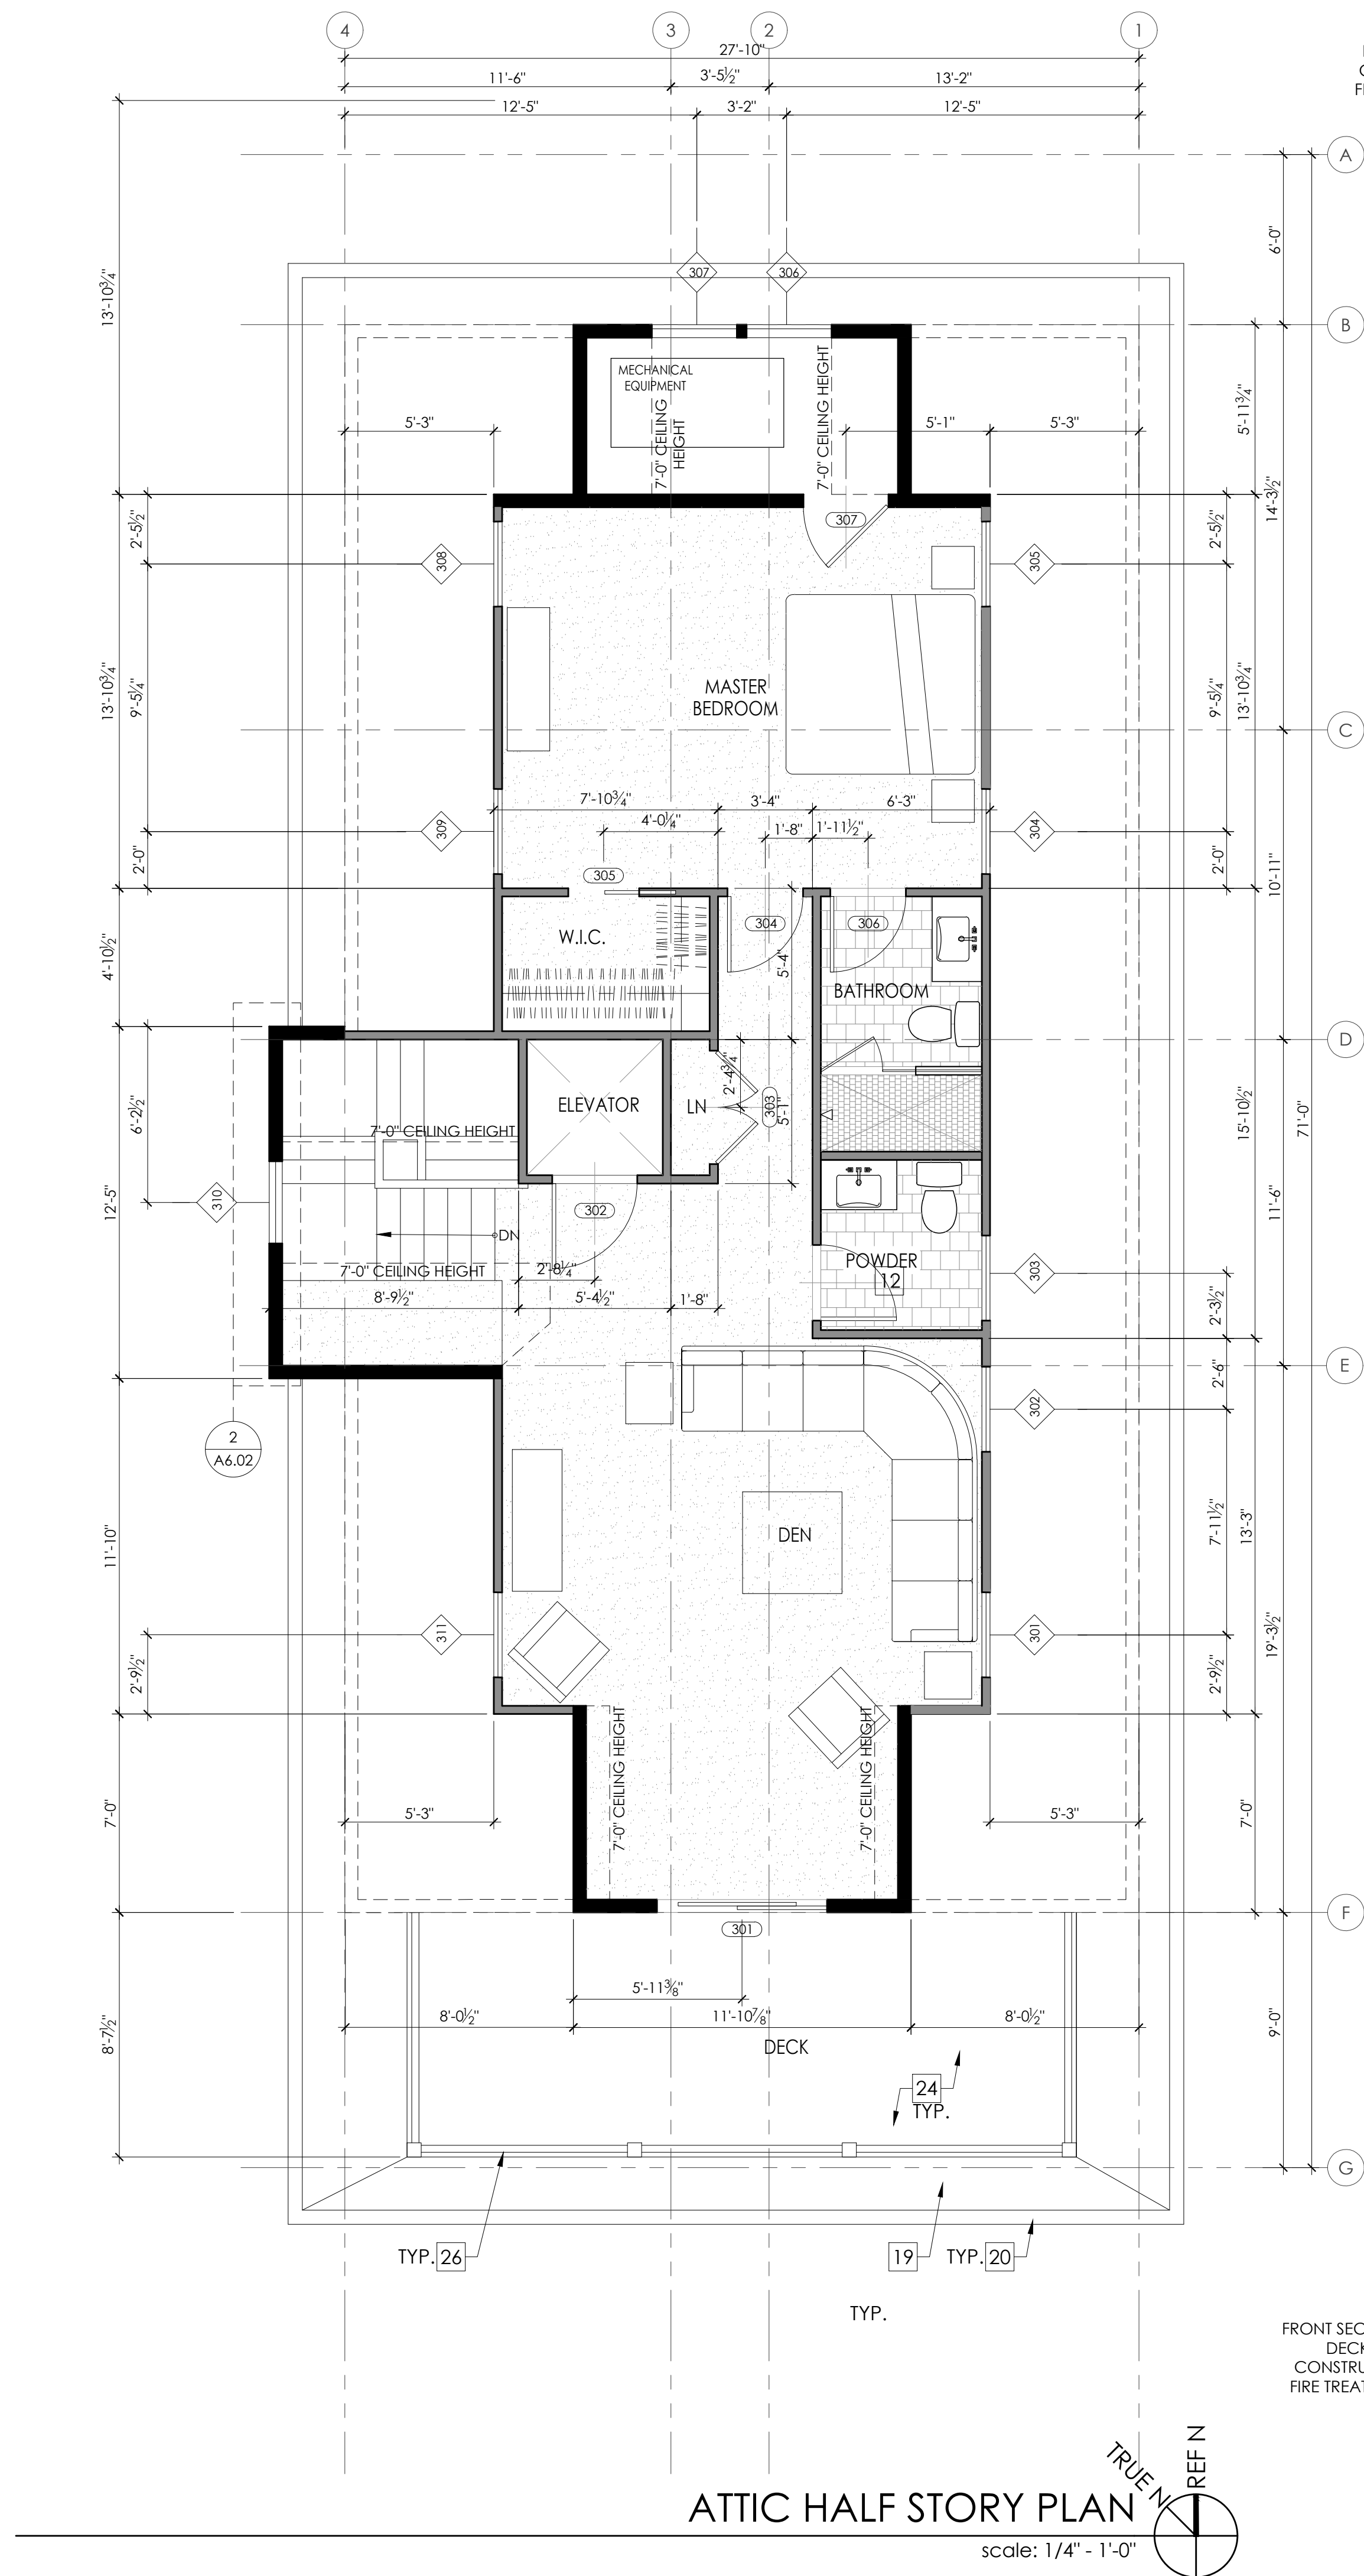

GENERAL NOTES

- DIMENSIONS ARE TO FACE OF FRAME UNLESS NOTED OTHERWISE.
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- REFER TO CONSTRUCTION NOTES ON A0.01 FOR ADDITIONAL INFORMATION
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WALL LEGEND

NOTE: P.T. LUMBER REQUIRED AT ALL LOCATIONS BELOW D.F.E.

- (N) 2X6 EXTERIOR LOAD BEARING WALL. P.T. LUMBER REQUIRED BELOW D.F.E.
- (N) 2X4 INTERIOR NON LOAD BEARING WALL

KEYNOTES

- (N) SMOOTH TROWELED STUCCO FINISHED WALL AT GARAGE AND CRAWLSPACE. REFER TO EXTERIOR ELEVATIONS.
- (N) VARYING WIDTH 4" AND 6" AZEK BOARD SCREENING UNDER DECK
- (N) CONCRETE SLAB ON GRADE W/ VISQUIM MESH
- (N) 4" THICK STRUCTURAL CONCRETE SLAB, TO BE POURED ON COMPACTED FILL W/ 6MM VISQUIM
- (N) GRAVEL
- (N) A.C. CONDENSER UNIT
- (N) HVAC UNIT SUSPENDED FROM CEILING ABOVE
- (N) OUTDOOR SHOWER ENCLOSURE WITH COMPOSITE DECKING FLOOR OVER GRAVEL WITH FRENCH DRAIN
- (N) CRAWLSPACE ACCESS PANEL
- (N) 6"x6" 1 HR FIRE TREATED STRUCTURAL POST WRAPPED WITH AZEK
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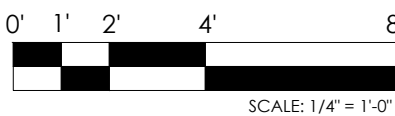
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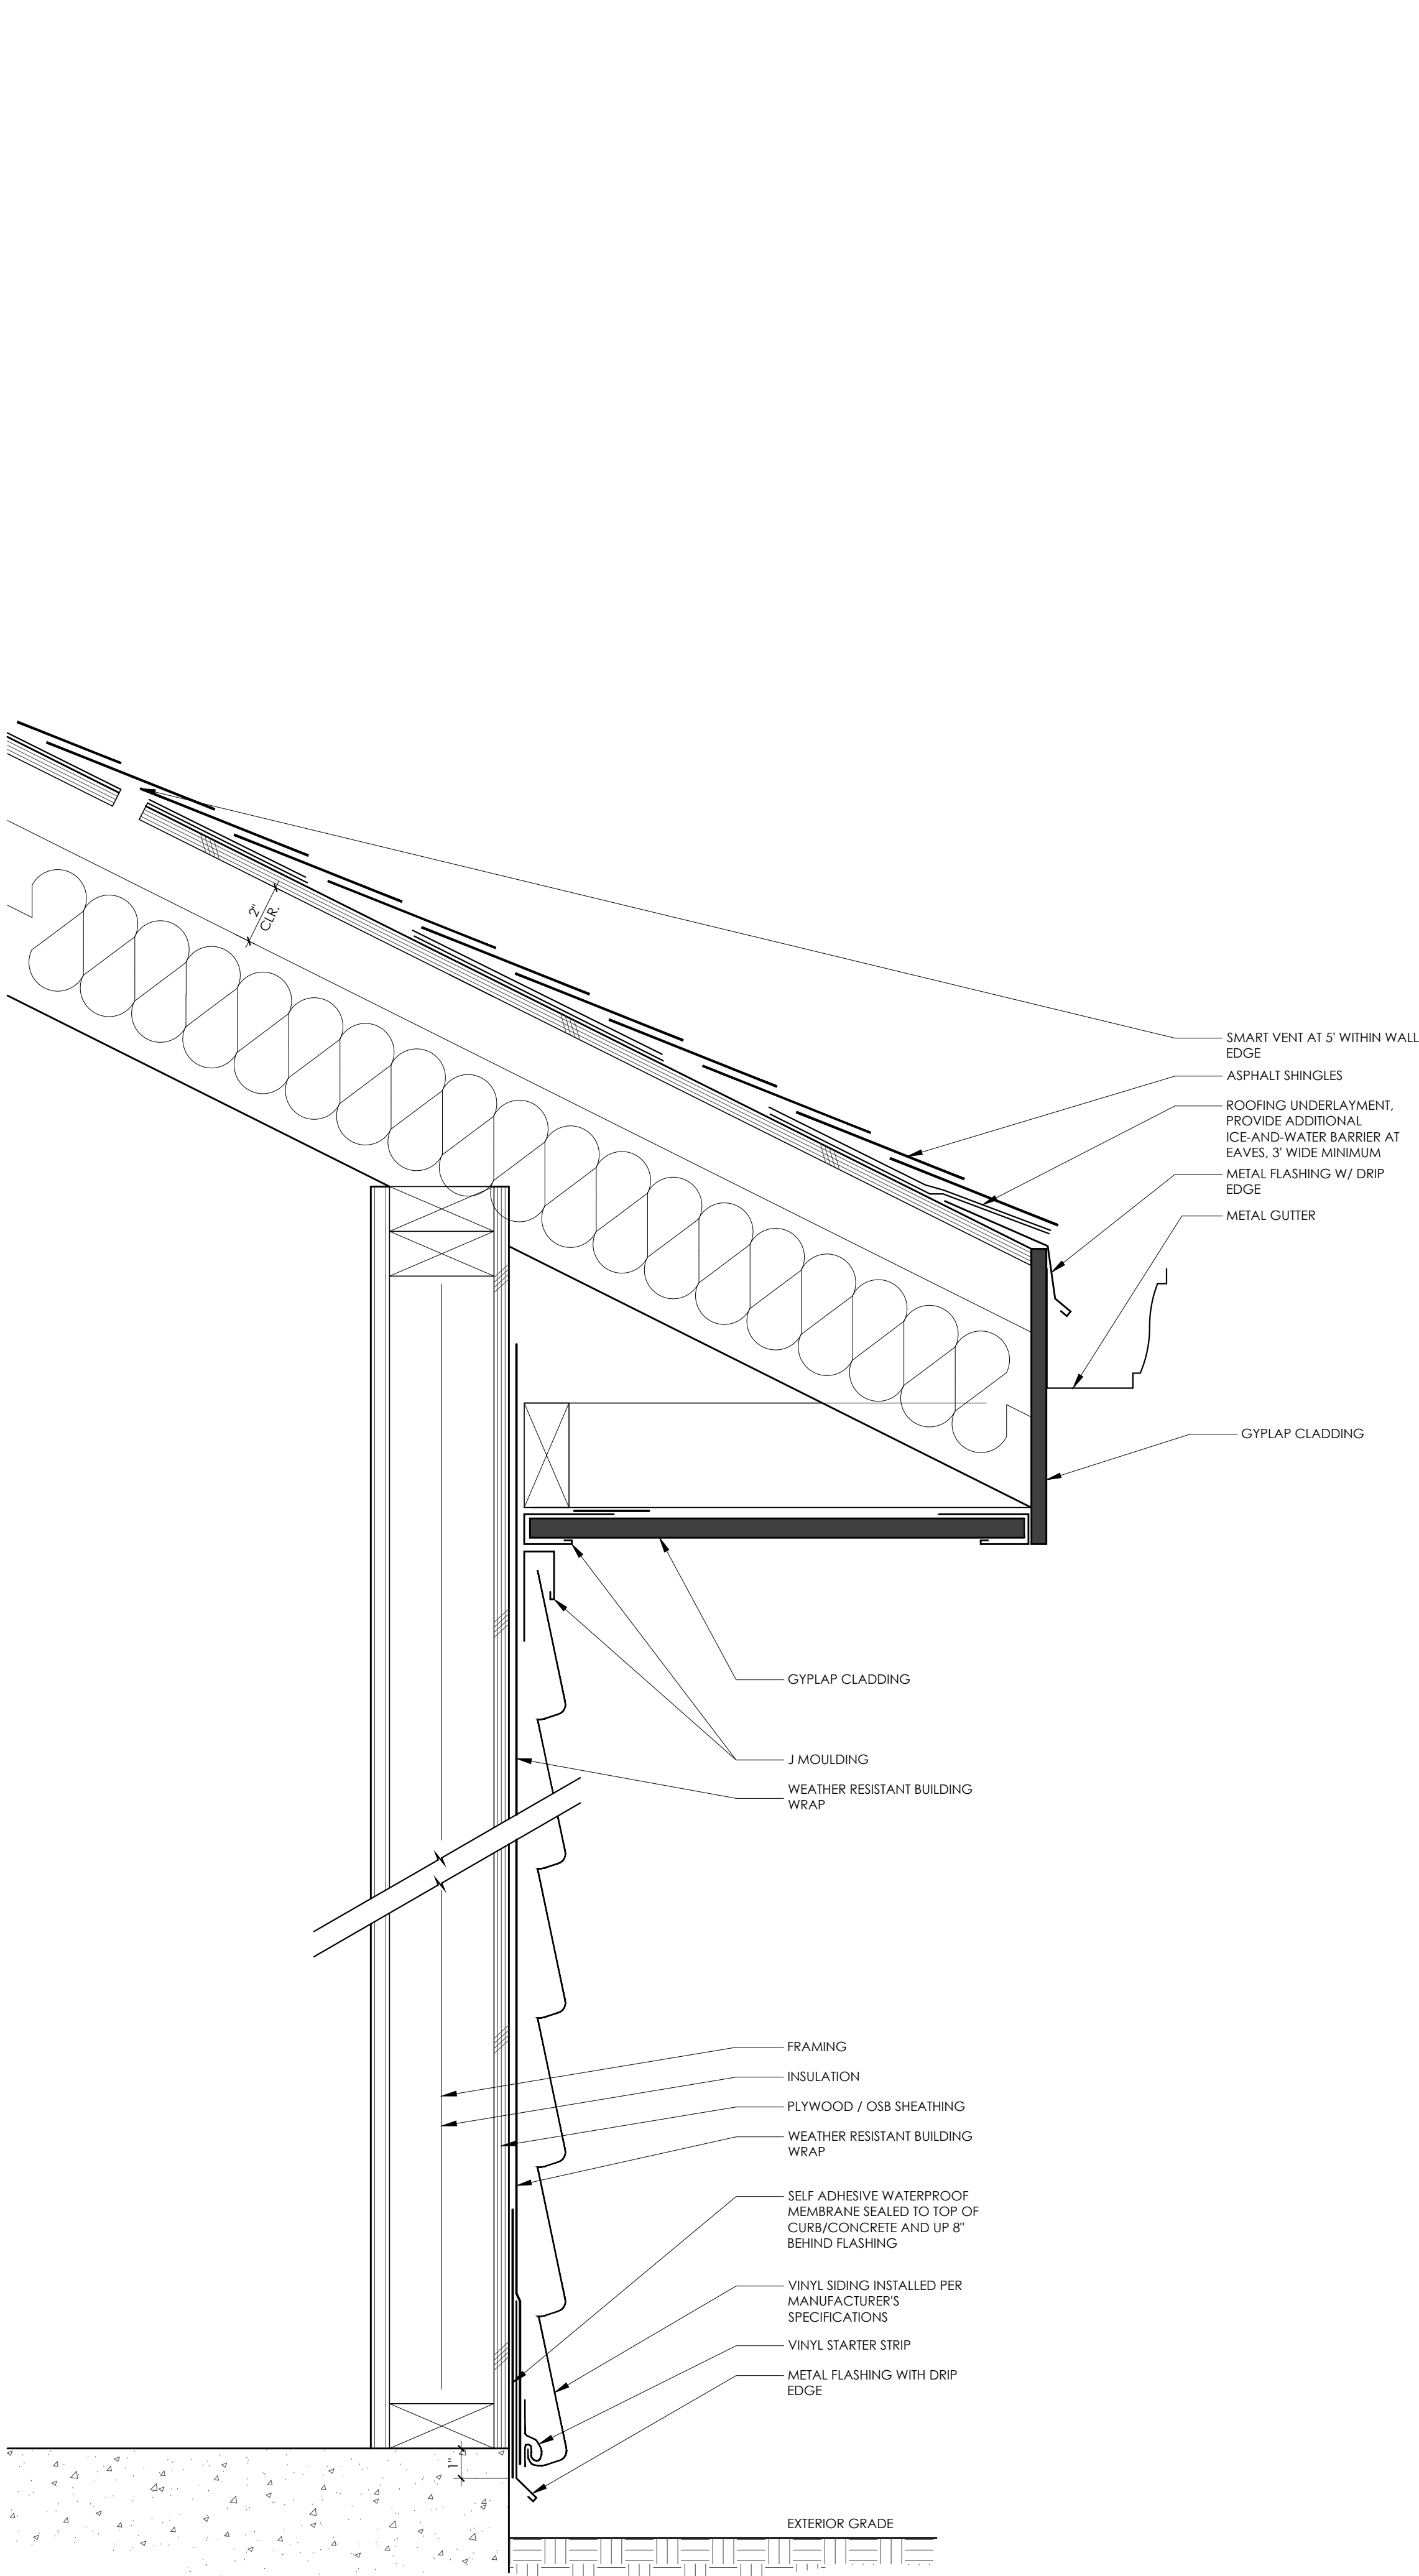
PLOT AND BLOCK
Lot 23.02
Block 403

SHEET NUMBER AND NAME:


A1.02

Second Floor
Plan
+
Roof Plan





SECTION: VINYL SIDING AND EAVE SOFFIT
scale: 3" = 1'-0"

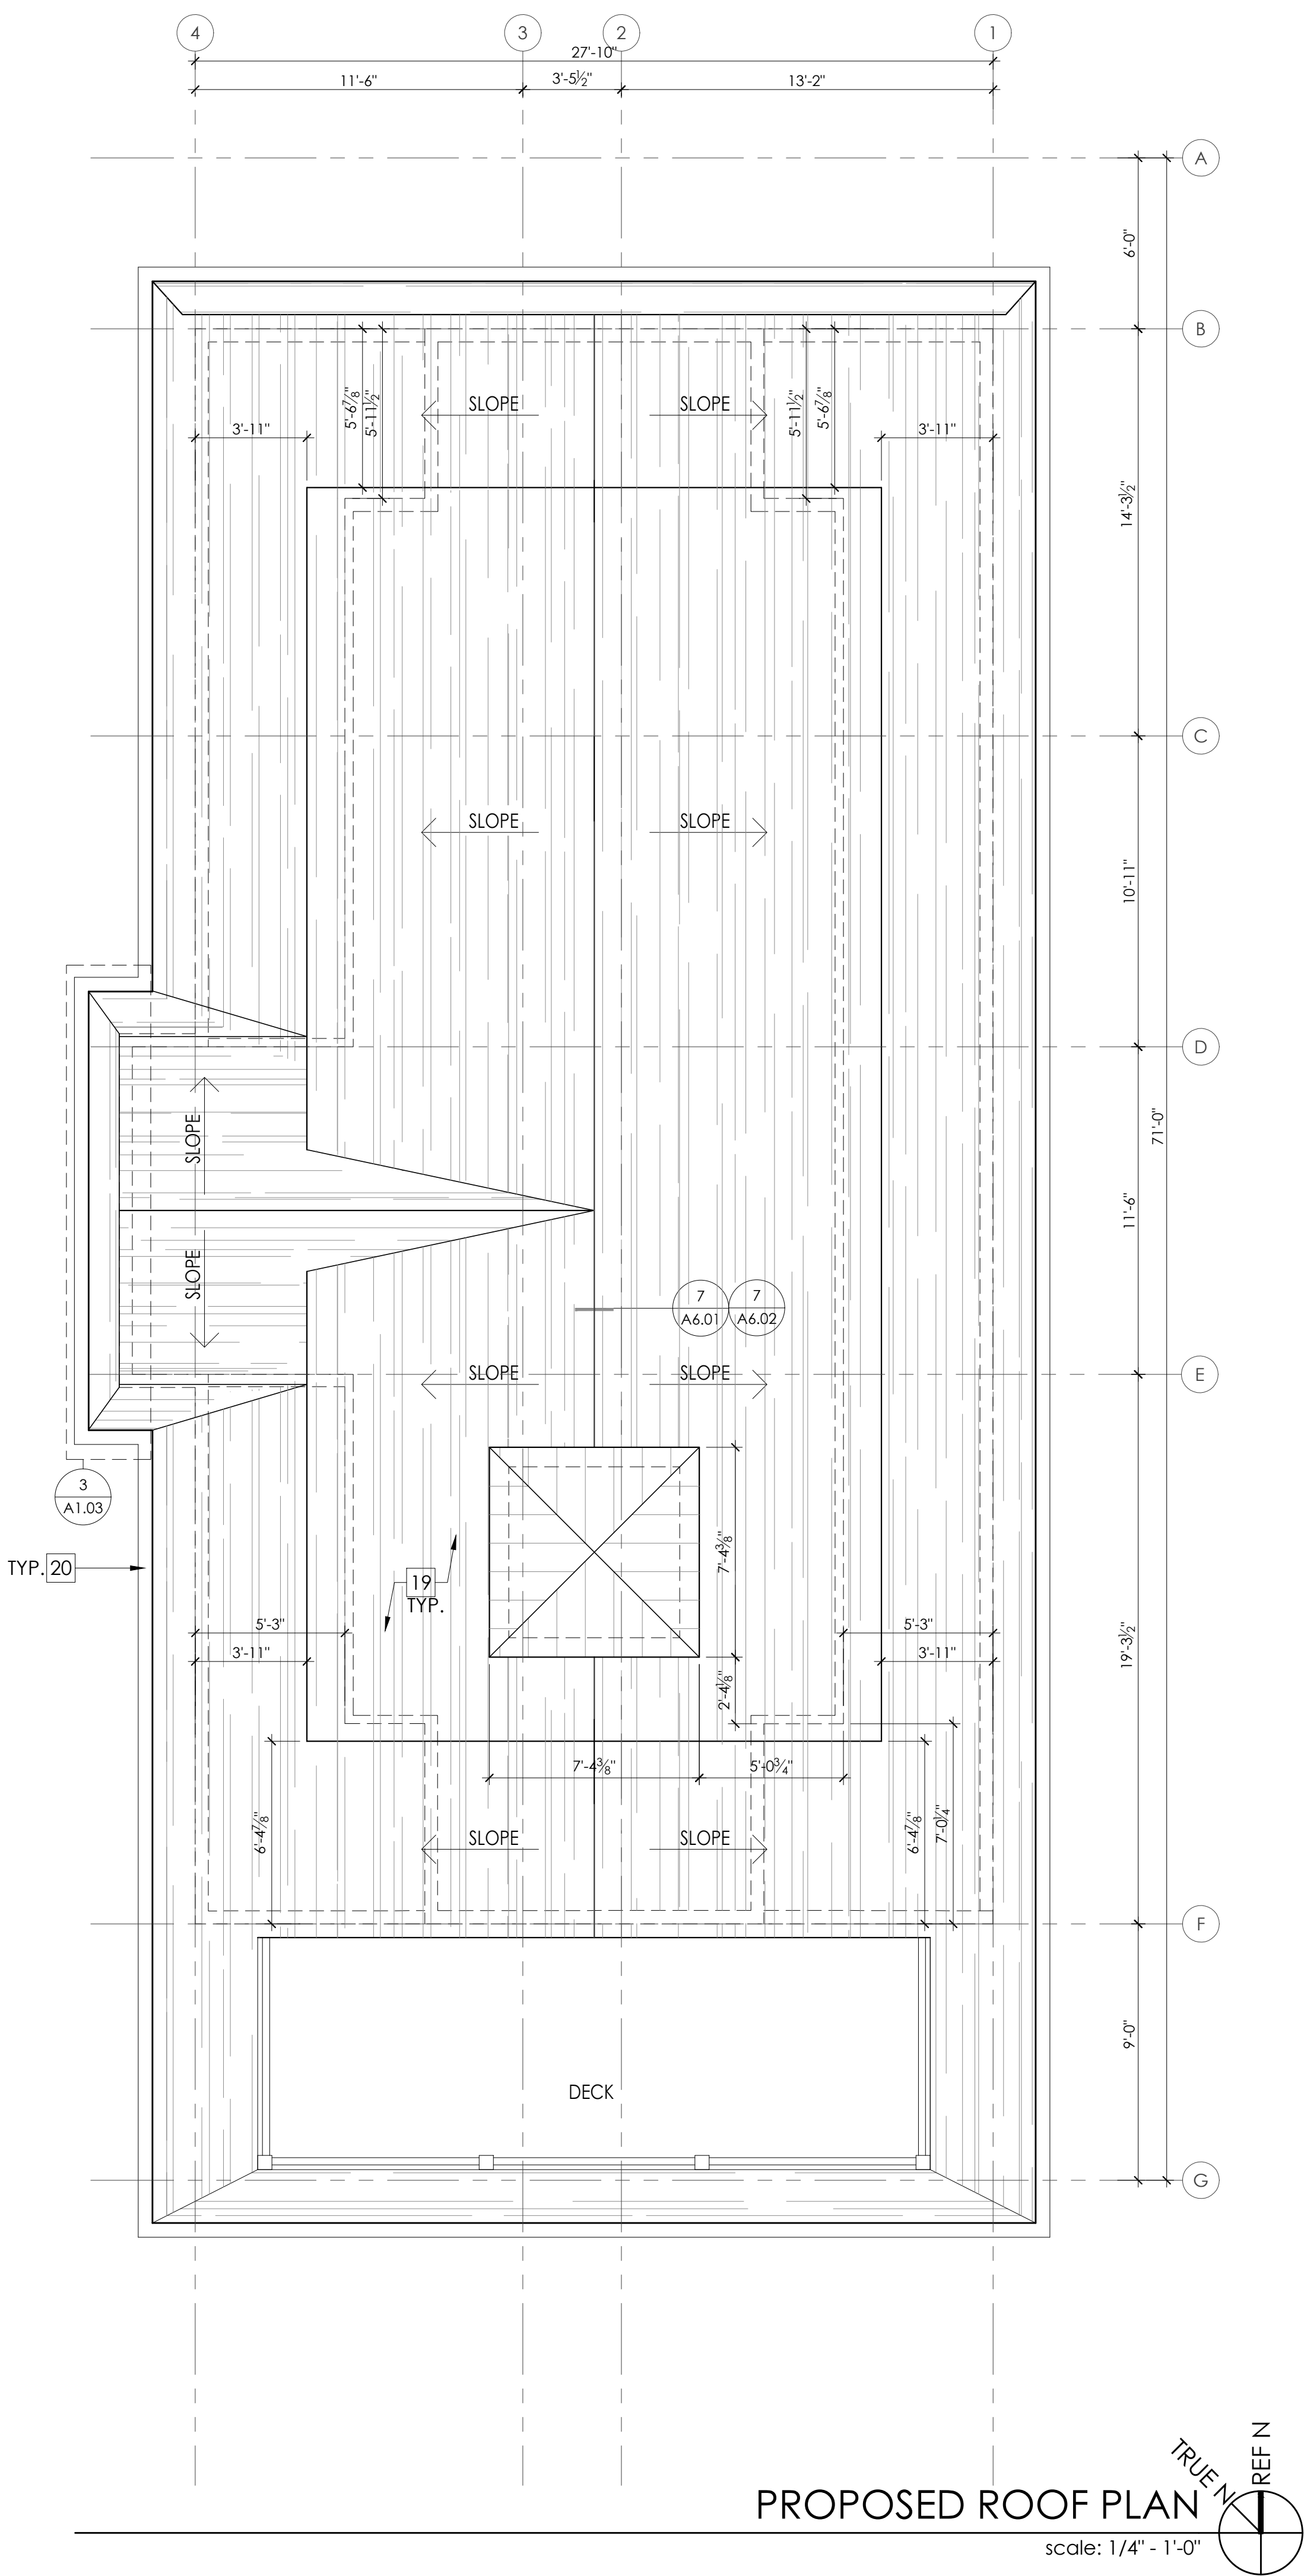

PROPOSED ROOF PLAN
scale: 1/4" = 1'-0"

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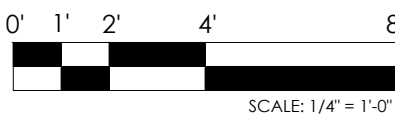
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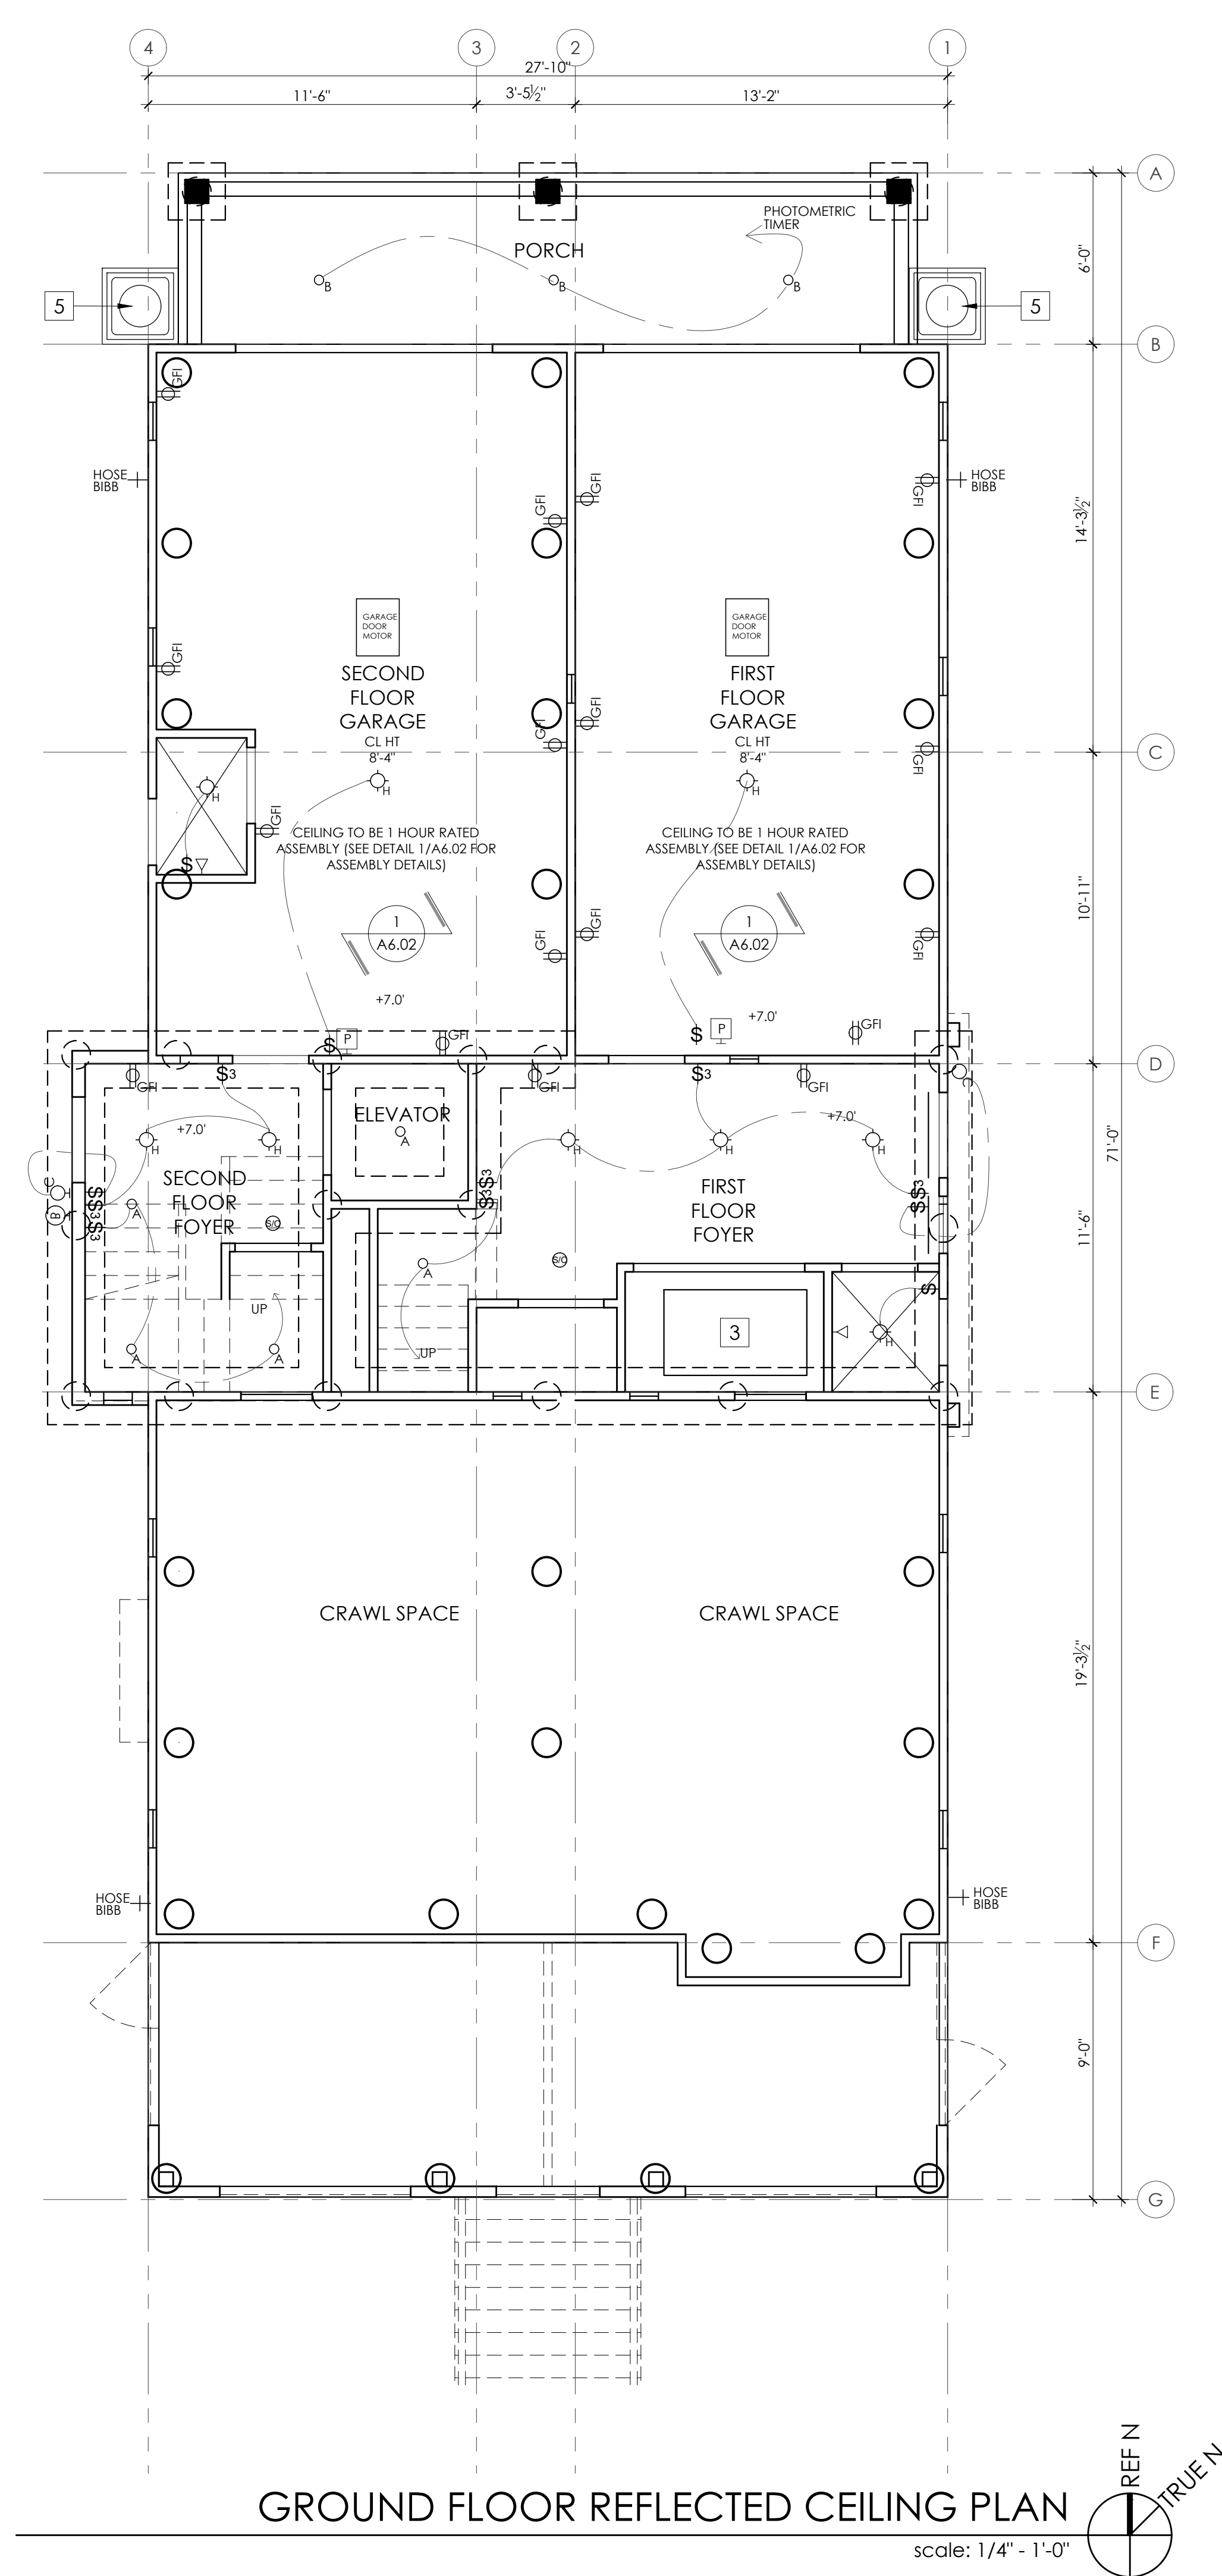
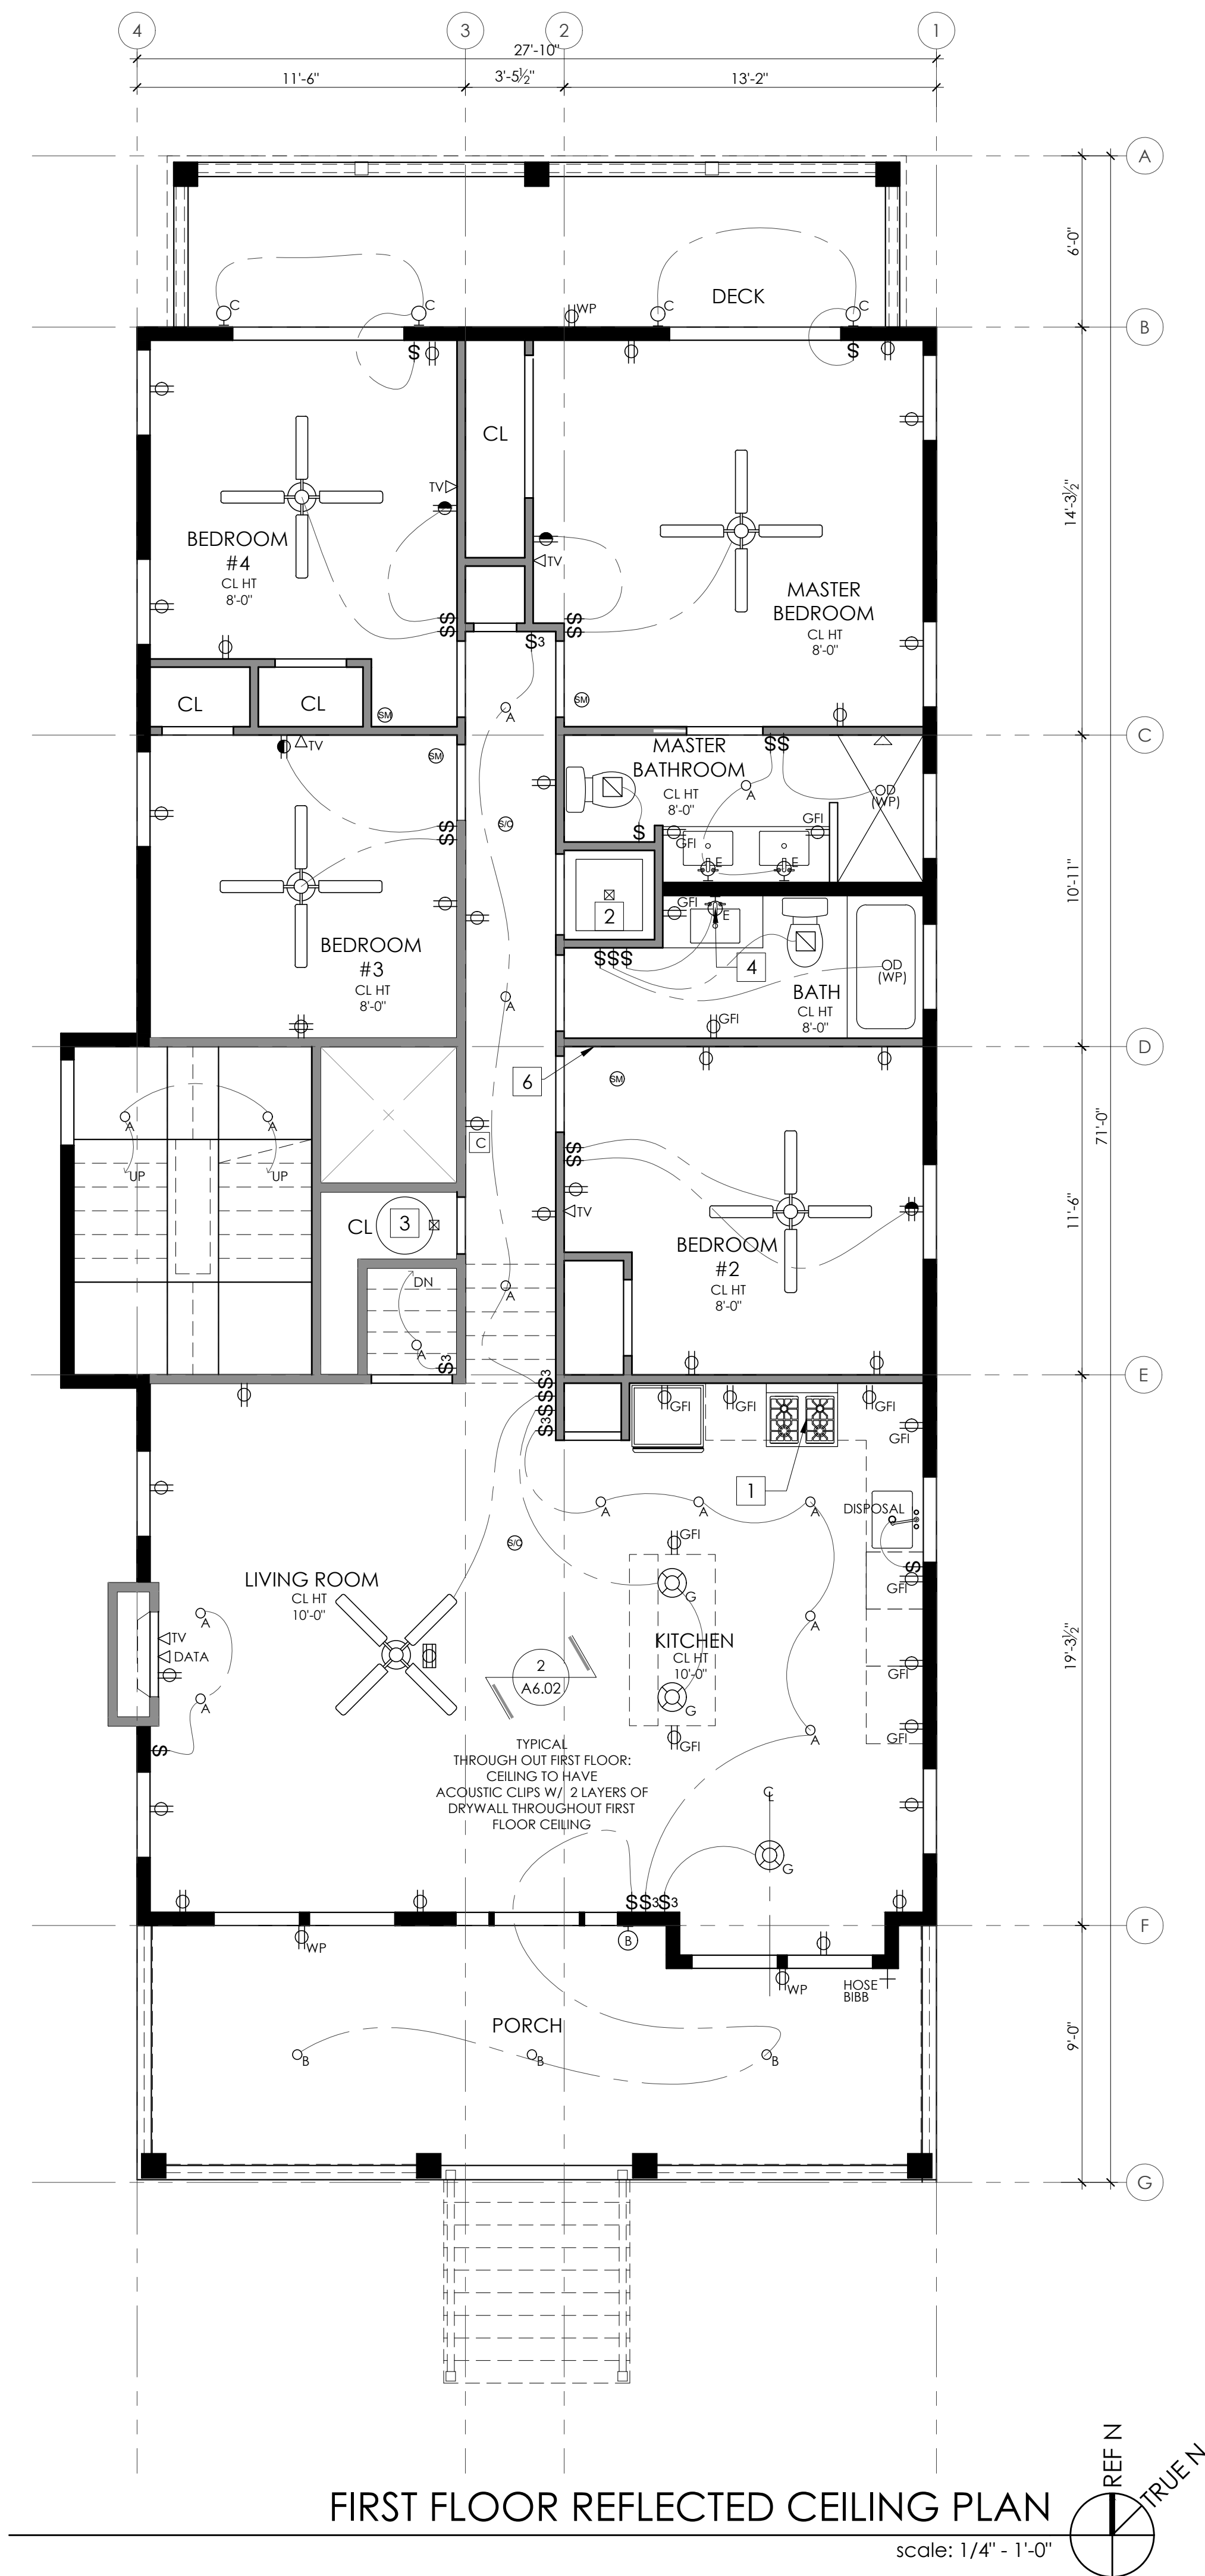
LOT AND BLOCK
Lot 23.02
Block 403

SHEET NUMBER AND NAME:

A1.03

Roof Plan





GENERAL ELECTRICAL NOTES

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3. AUDIO VISUAL EQUIPMENT TO BE CONTRACTED SEPARATELY

RCP KEYNOTES

1 (N) KITCHEN HOOD AND RANGE (PROVIDE GAS AND OR ELECTRICAL AS REQUIRED)

2 (N) ELECTRICAL/GAS SERVICE FOR WASHER/ DRYER TO BE CONNECTED TO INDIVIDUAL, PROPERLY GROUNDED BRANCH CIRCUIT WITH 120/240V OR 120/208V SINGLE PHASE 60 HZ ELECTRICAL SERVICE AND SHOULD BE PROTECTED BY 30 AMP TIME DELAY FUSES OR CIRCUIT BREAKERS KW RATING PER VOLTAGE (240/208.)

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4 (N) WALL SCONCE LOCATED ABOVE THE VANITY AND MIRROR CENTERED ON THE VANITY (FIXTURE TO BE SELECTED BY OWNER). OWNER TO CONFIRM MOUNTING HEIGHT.

5 (N) HVAC CONDENSER (INSTALLED PER MANUFACTURERS REQUIREMENTS)

6 FLUSH MOUNTED ELECTRICAL PANEL

ELECTRICAL SYMBOL LEGEND

(N) "PROGRESS" 4" ZERO SIGHT LINE RECESSED DOWN LIGHT DIMMABLE WHERE NOTED

(N) "PROGRESS" EXTERIOR 4" ZERO SIGHT LINE RECESSED DOWN LIGHT

(N) EXTERIOR WALL MOUNTED SCONCE (TO BE SELECTED BY OWNER)

(N) WATERPROOF FIXTURE

(N) INTERIOR WALL MOUNTED SCONCE (TO BE SELECTED BY OWNER)

(N) UNDERCOUNTER LED TAPE LIGHT

(N) CEILING HUNG PENDENT/ CHANDELIER TO BE SELECTED BY OWNER

(N) SURFACE MOUNTED CLNG. FIXTURE (TO BE SELECTED)

(N) NOT USED

(N) NOT USED

(N) EXHAUST FAN BY PANASONIC; GREEN WHISPER FAN (NO LIGHT)

(N) CEILING FAN W/ INTEGRAL LIGHT (SPECIFICATION TO BE SELECTED BY OWNER)

(N) CAT5 DATA CABLE HOOKUP

(N) TELEVISION CABLE HOOKUP

(N) TELEPHONE OUTLET

(N) 120 V DUPLEX FLOOR OUTLET

(N) 120 V DUPLEX OUTLET

(N) 120 V GROUND FAULT INTERRUPTER

(N) 120 V ARC FAULT CIRCUIT INTERRUPTER

(N) 120 V DUPLEX OUTLET TOP HALF SWITCH

(N) 120 V WEATHERPROOF DUPLEX OUTLET

(N) SINGLE POLE SWITCH

(N) THREE-WAY SWITCH

(N) SINGLE POLE DIMMER

(N) MANUAL ON MOTION SENSOR SWITCH

(N) MOTION SENSOR - WET RATED

(N) THERMOSTAT

(N) DOORBELL CHIMES

(N) DOORBELL BUTTON

(N) PUSH BUTTON GARAGE DOOR OPERATION SWITCH

(N) CEILING MOUNTED SMOKE AND CARBON MONOXIDE DETECTORS WITH BATTERY BACKUP

(N) CEILING MOUNTED SMOKE DETECTORS WITH BATTERY BACKUP



Halliday Architects

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email: chris@hallidayarchitects.com
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CHRISTOPHER HALLIDAY L1#21A101936000

SUBMITTAL INFO./ DATE

PROJECT INFORMATION: 2129

DATE: 05.05.2021 DRAWN BY: CMH
PROJECT 1

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OWNER CONTACT I
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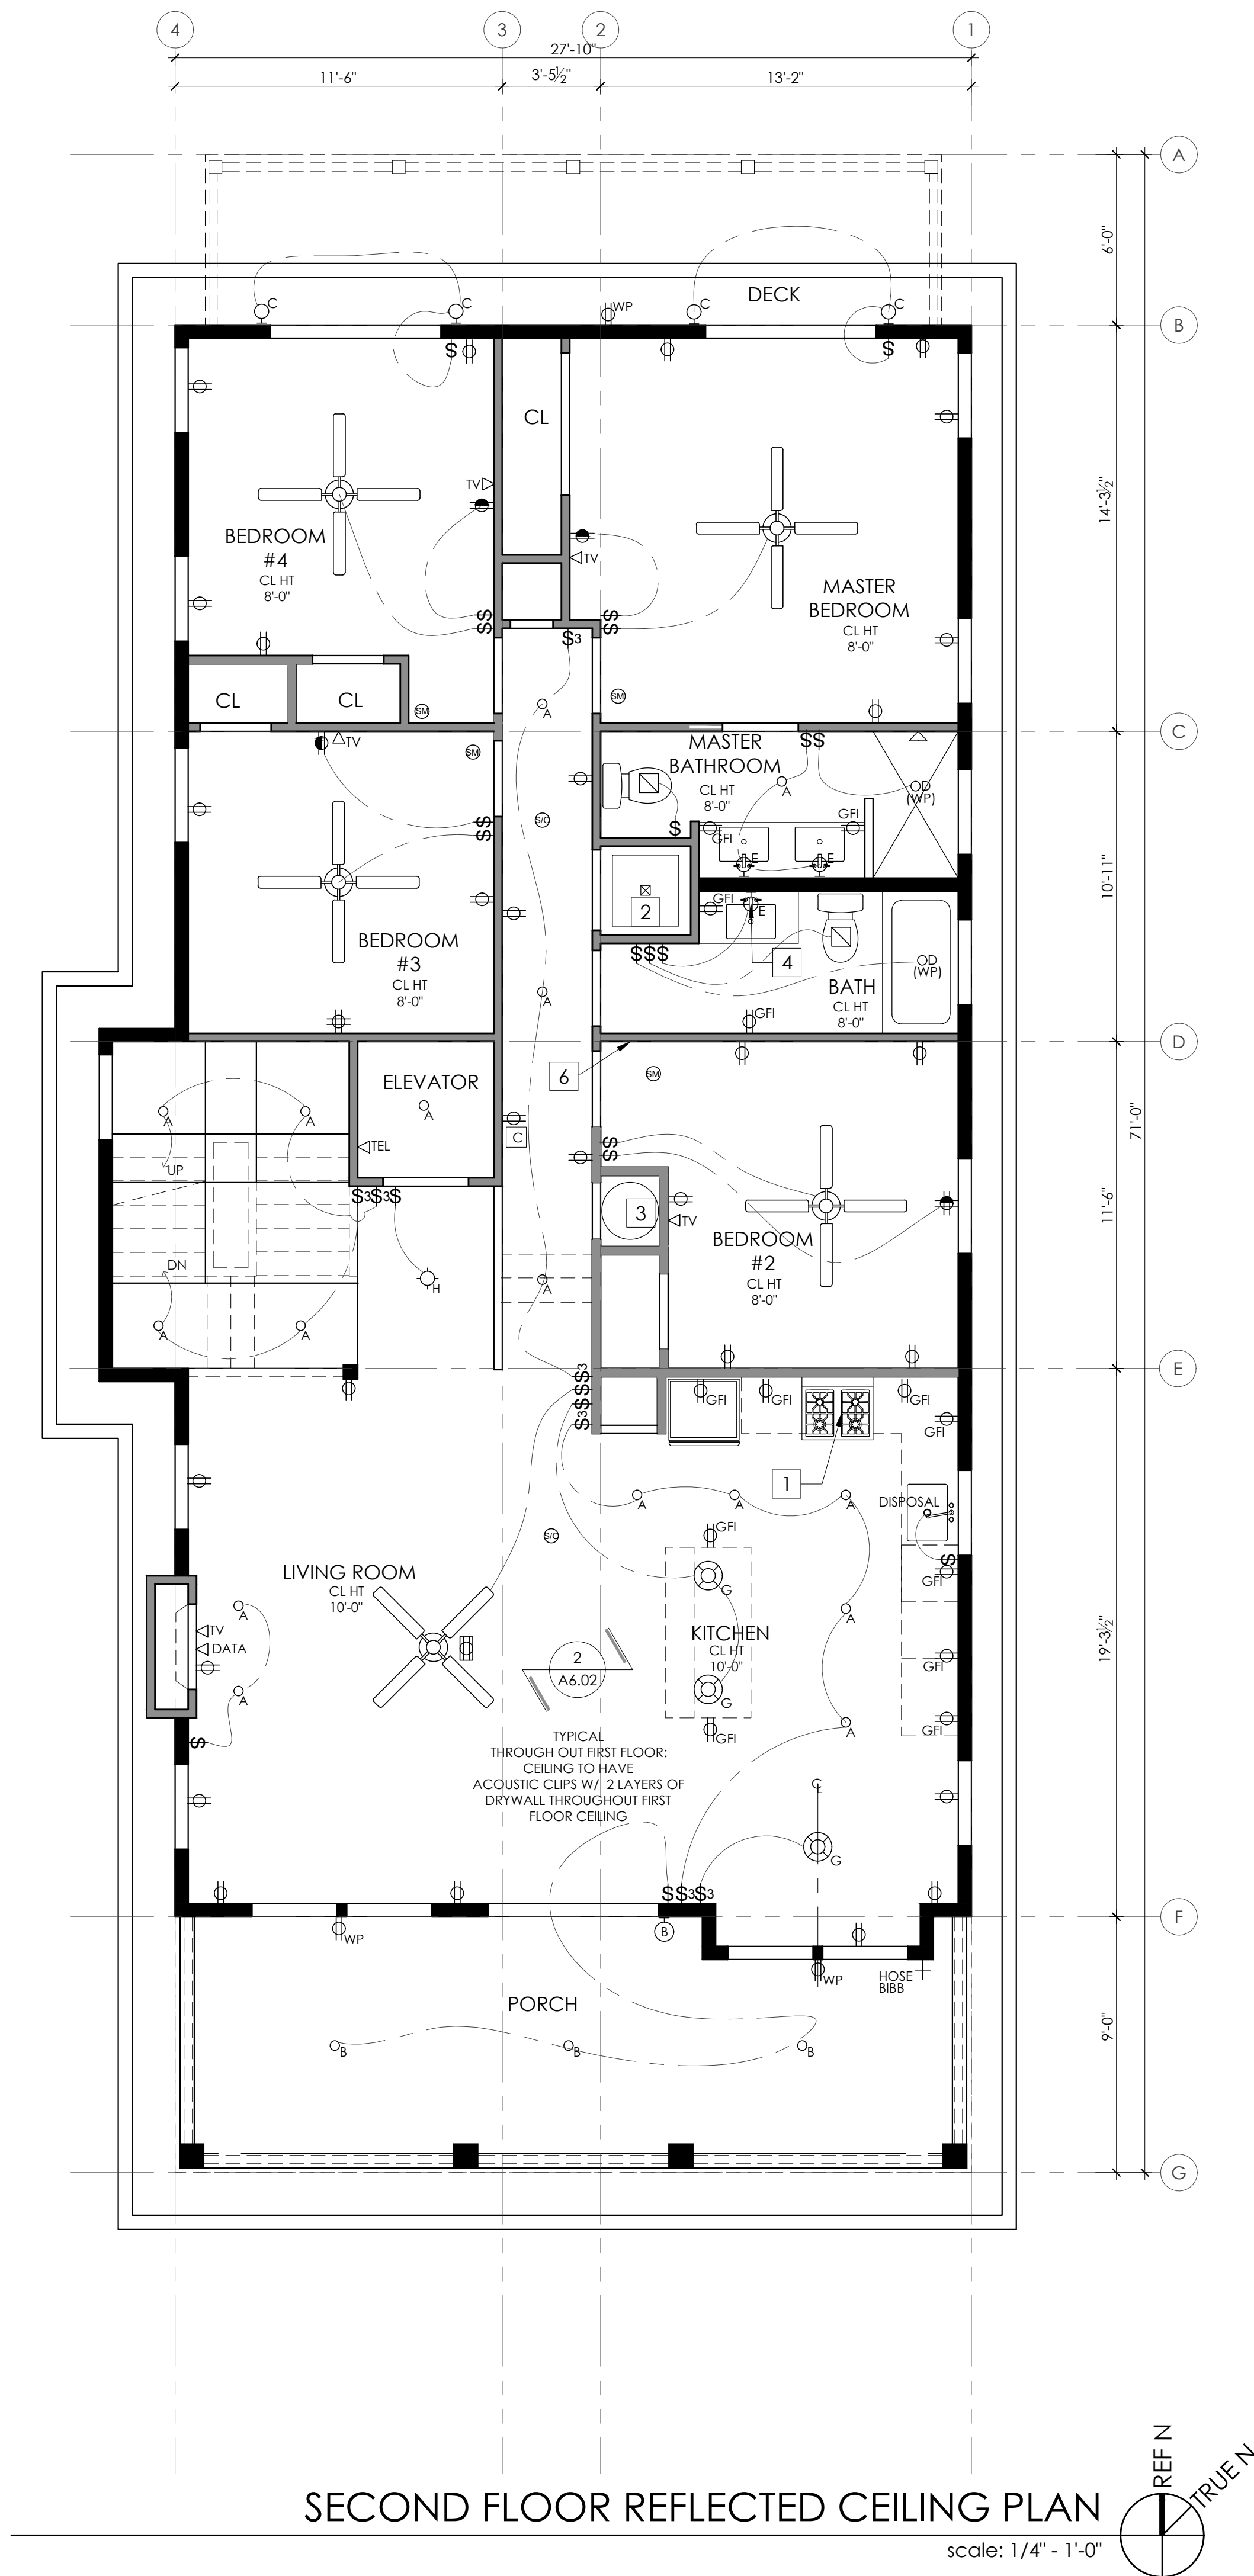
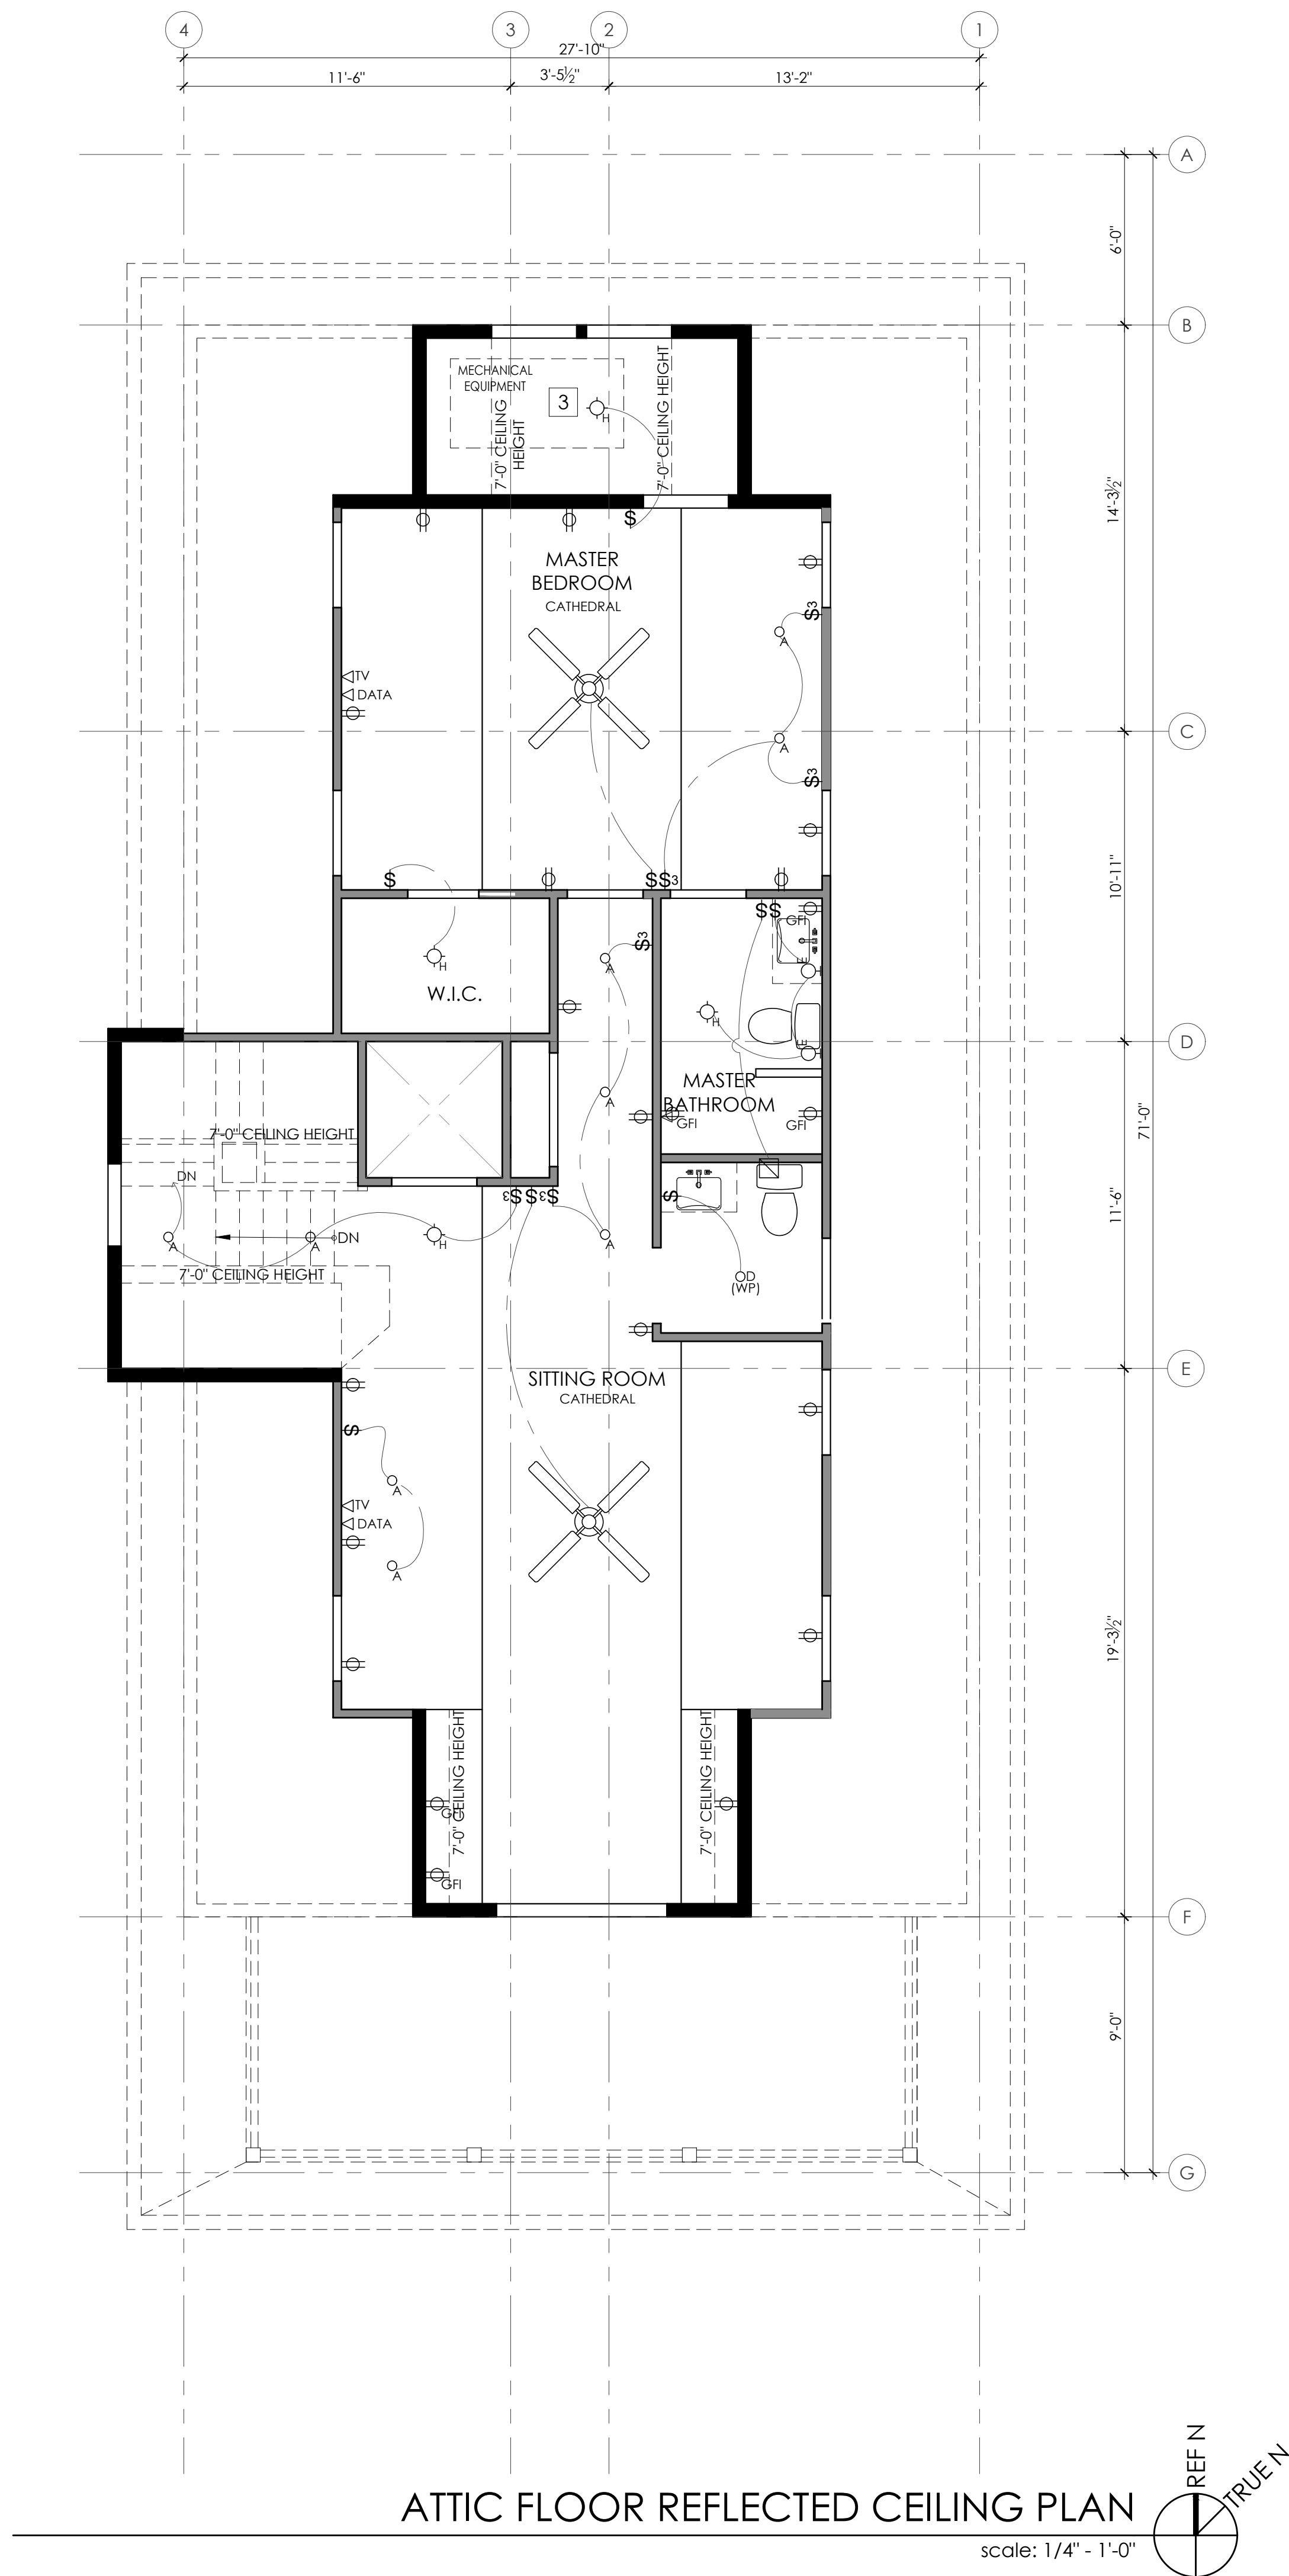
LOT AND BLOCK I
Lot 23.02
Block 403

SHEET NUMBER AND NAME:

A2.01

Ground + First
Floor
Reflected Ceiling
Plans

0' 1' 2' 4' 8'
SCALE 1/4" = 1'-0"



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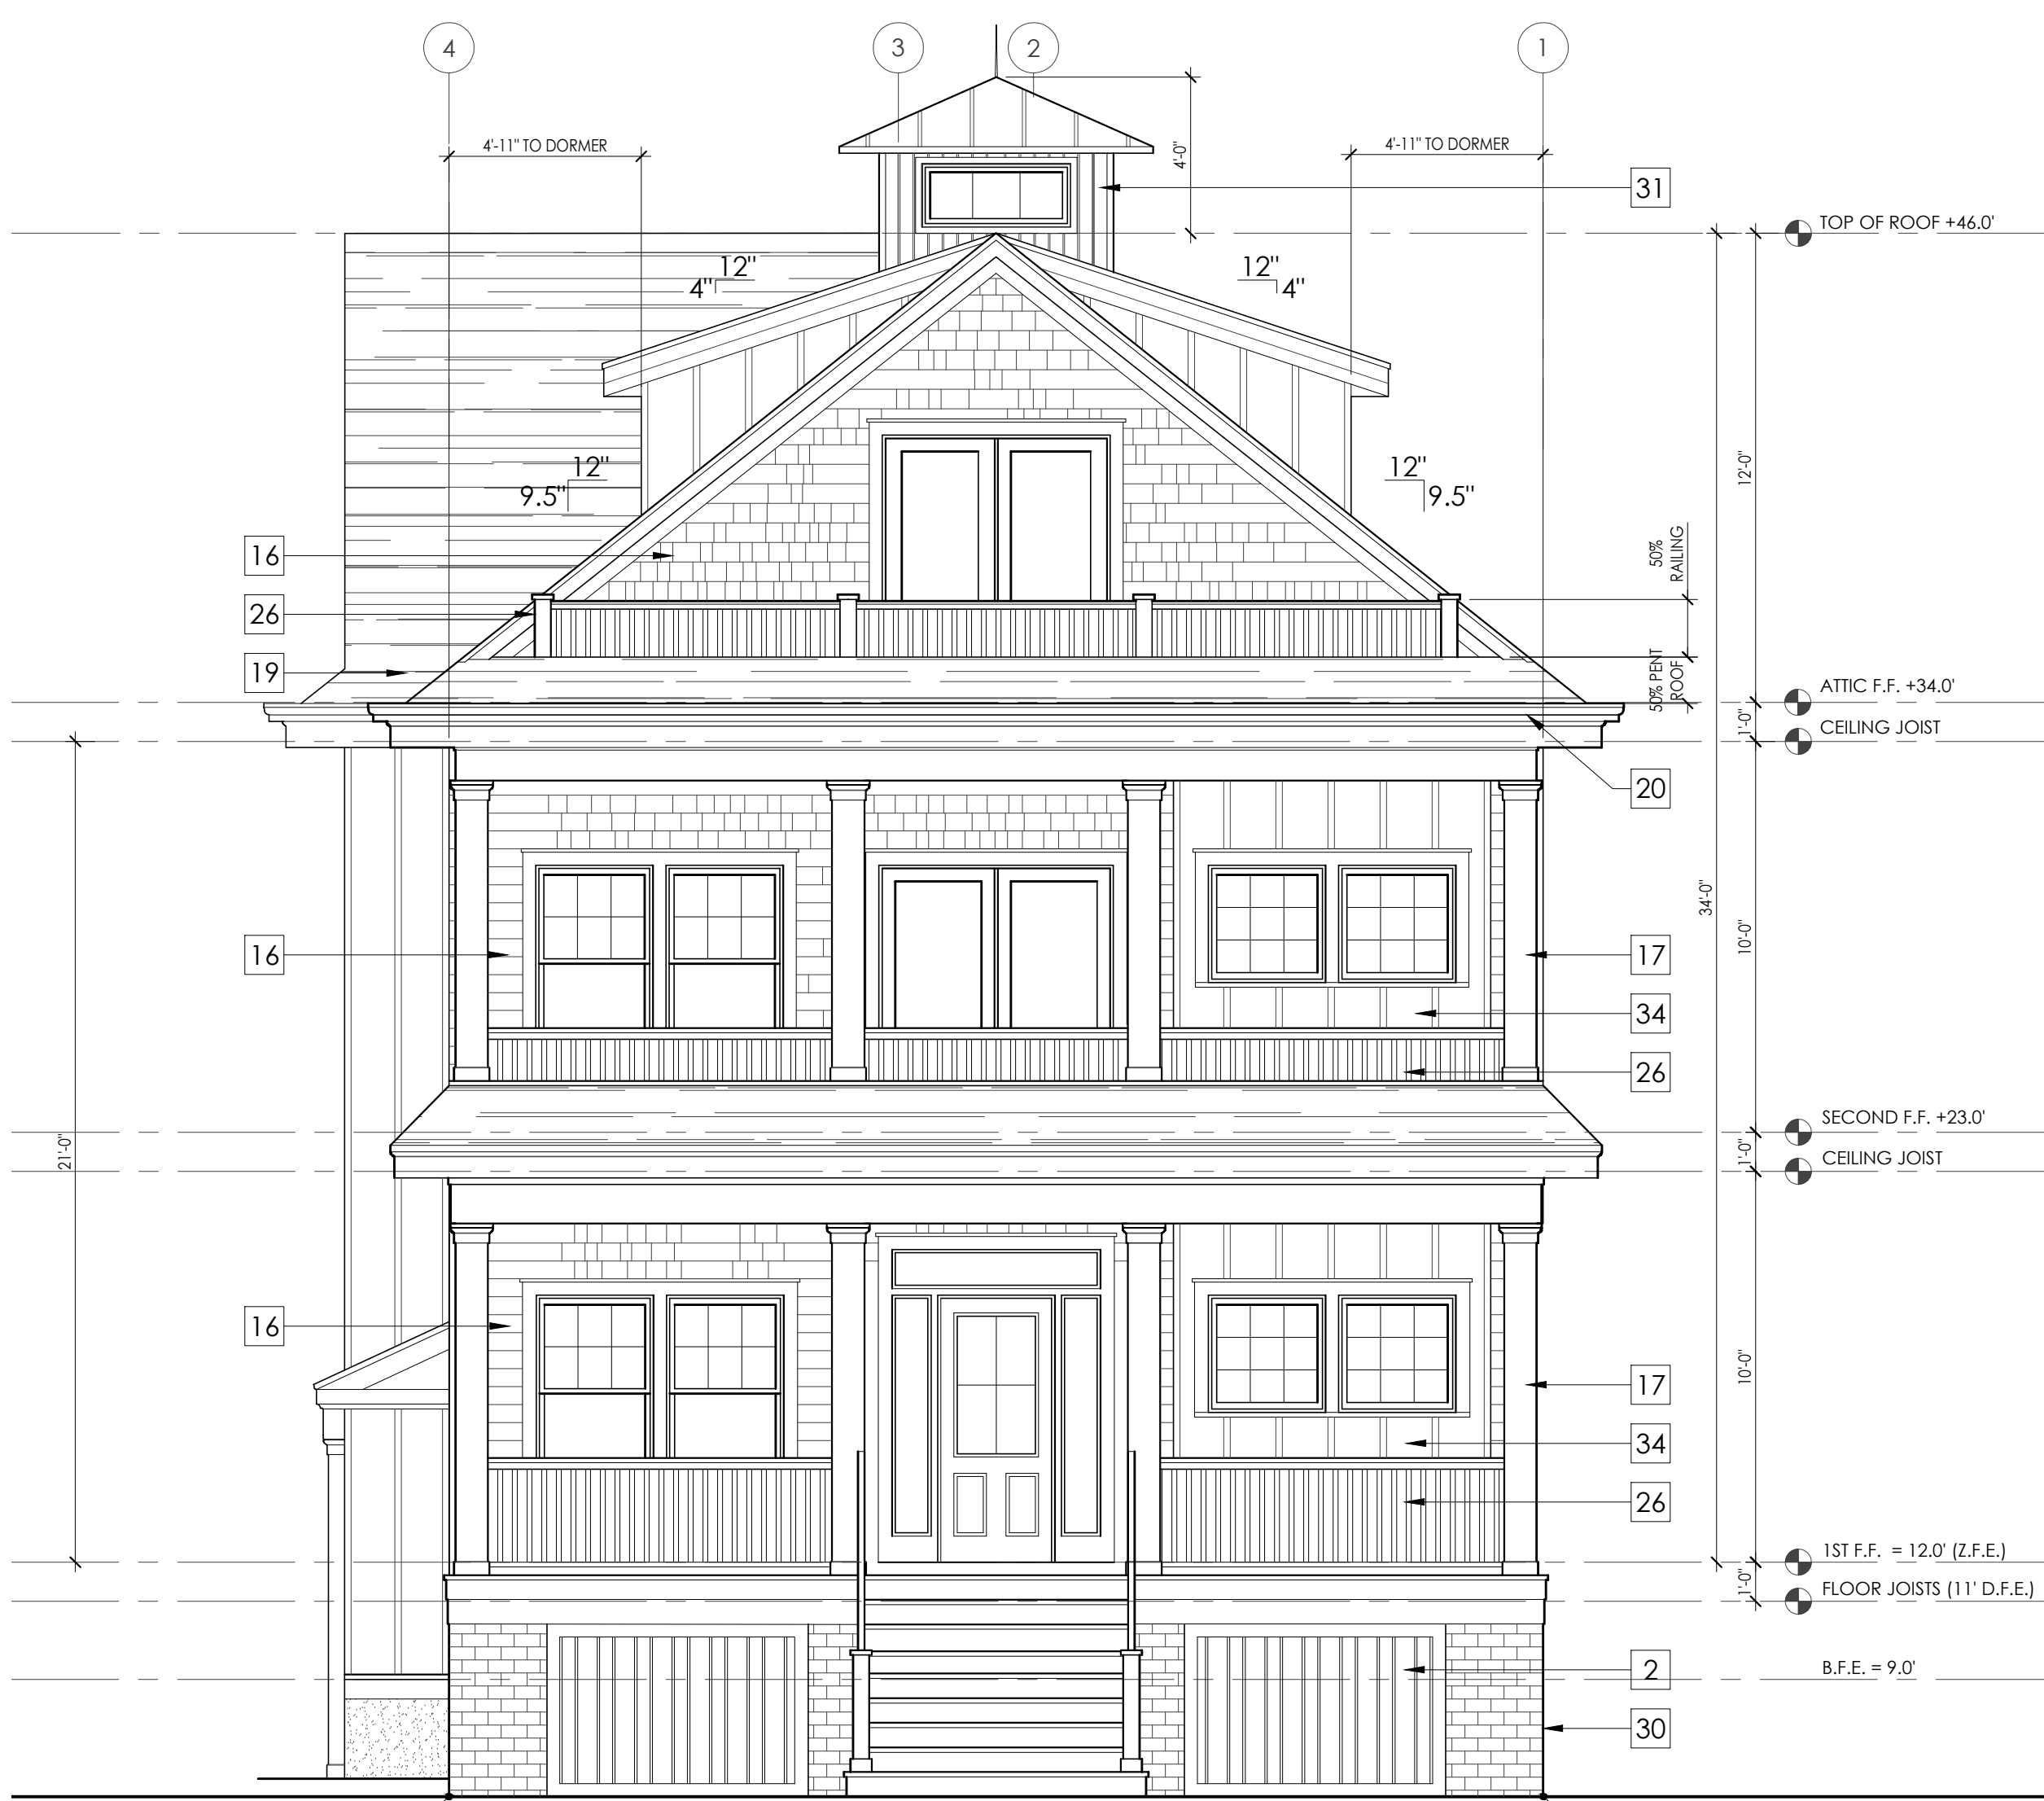
SHEET NUMBER AND NAME:

A2.02

Second Floor +
Attic Floor Plan
Reflected Ceiling
Plan

0' 1' 2' 4' 8'

SCALE: 1/4" = 1'-0"



5TH STREET (FRONT) ELEVATION
scale: 1/4" = 1'-0"



SIDE (WEST) ELEVATION
scale: 1/4" = 1'-0"

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WALL LEGEND

NOTE: P.T. LUMBER REQUIRED AT ALL LOCATIONS BELOW D.F.E.

- (N) 2X6 EXTERIOR LOAD BEARING WALL, P.T. LUMBER REQUIRED BELOW D.F.E.
- (N) 2X4 INTERIOR NON LOAD BEARING WALL

KEYNOTES

- (N) SMOOTH TROWELED STUCCO FINISHED WALL AT GARAGE AND CRAWLSPACE. REFER TO EXTERIOR ELEVATIONS.
- (N) VARYING WIDTH 4" AND 6" AZEK BOARD SCREENING UNDER DECK
- (N) CONCRETE SLAB ON GRADE W/ VISQUIM MESH
- (N) 4" THICK STRUCTURAL CONCRETE SLAB, TO BE POURED ON COMPACTED FILL W/ 6MM VISQUIM
- (N) GRAVEL
- (N) A.C. CONDENSER UNIT
- (N) HVAC UNIT SUSPENDED FROM CEILING ABOVE
- (N) OUTDOOR SHOWER ENCLOSURE WITH COMPOSITE DECKING FLOOR OVER GRAVEL WITH FRENCH DRAIN
- (N) CRAWLSPACE ACCESS PANEL
- (N) 6"X6" 1 HR FIRE TREATED STRUCTURAL POST WRAPPED WITH AZEK
- (N) 5'-0" FIBERGLASS SHOWER/TUB INSERT
- (N) TILED SHOWER WITH FIBERGLASS PAN AND GLASS DOOR/ENCLOSURE
- FLOOD VENT: "SMART VENT" MODEL #1540-520, 8 1/2"X14 1/2", PROVIDING COVERAGE FOR 200 SQUARE FEET EA.
- (N) INTERIOR SCREEN VENT
- (N) FLOOR DRAIN
- (N) CERTAINTED TRIPLE 5" STRAIGHT EDGE SAWMILL SHINGLES (COLOR TO BE SELECTED BY OWNER)
- (N) 10" SQUARE FLAT FIBERGLASS COLUMN WITH BASE AND CAP PER THE ELEVATIONS, OVER 6"X6" P.T. POST
- (N) WATER RESISTANT GYP. BOARD BELOW Z.F.E. (@ GARAGE AND CRAWL SPACE INTERIOR))
- ASPHALT SHINGLE ROOF. COLOR T.B.D.
- GUTTER/DOWNSPOUT, COLOR T.B.D.
- GAS FIREPLACE TO BE SELECTED BY OWNER
- NON-COMBUSTIBLE FIREPLACE HEARTH
- COMPOSITE DECKING SECURED TO DECK STRUCTURE, SLOPE AWAY FROM HOUSE @ 2% MIN, COLOR T.B.D.
- (N) FIBERGLASS DECK COATING, SLOPE AWAY FROM HOUSE. (FRAMING TO BE TREATED/ DECKING TO BE FIRE SPRAYED)
- (N) EXTERIOR STAIR TO HAVE 4X4 POSTS (WHERE REQUIRED) W/ 2X12 STRINGERS @ 12" O.C.
- STAIR/DECK GUARDRAIL, 36" MIN. WHITE VINYL FINISH
- EXTERIOR WALL SCONCE, REFER TO REFLECTED CEILING / POWER PLANS ON A2.01 + A2.02
- PULL DOWN ATTIC STAIR/LADDER, CONTRACTOR TO COORDINATE WITH OPENING WITH FRAMING
- CERTAINTED 5" SHIPLAP SIDING (COLOR TO BE SELECTED BY OWNER)
- BRICK VENEER OVER PRESSURE TREATED PLYWOOD
- VERTICAL BEADBOARD PVC SHIPLAP CUPOLA WITH STANDING SEAM METAL ROOF
- 10" PILLAR COLUMN WITH STANDING SEAM ROOF
- PVC PANELLING PER ELEVATION
- CERTAINTED BOARD AND BATTEN SIDING (COLOR TO BE SELECTED BY OWNER)



Halliday Architects

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email: chris@hallidayarchitects.com
Tel: 609.957.6789
Address: P.O. Box 186
Ocean City, NJ 08226

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PROJECT TEAM:

SIGNATURE
CHRISTOPHER HALLIDAY

L1#21A101936000

SUBMITTAL INFO. / DATE

PROJECT INFORMATION: 2129

DATE: 05.05.2021 DRAWN BY: CMH

PROJECT

861-63 5th Street
Ocean City, NJ

PROJECT ADDRESS

861-63 5th Street
Ocean City, NJ
08226

OWNER CONTACT:

861-867 Fifth Street LLC
11 E 9th Street Suite 3
Ocean City NJ, 08226

LOT AND BLOCK

Lot 23.02
Block 403

SHEET NUMBER AND NAME:

A3.01

Elevations



SCALE: 1/4" = 1'-0"



ALLEY (REAR) ELEVATION 2
scale: 1/4" = 1'-0"



SIDE (EAST) ELEVATION 1
scale: 1/4" = 1'-0"

GENERAL NOTES

1. DIMENSIONS ARE TO FACE OF FRAME UNLESS NOTED OTHERWISE.
2. DIMENSIONS WITH "CLR" ARE FINISH DIMENSIONS REQUIRED BY CODE.
3. ALL EXTERIOR WINDOWS AND DOORS ARE TO BE INSTALLED WITH (2) 2X10 BUILT UP STRUCTURAL HEADER BEARING ON 3 1/2" X 3 1/2" DBL JACKS.
4. HURRICANE CLIPS TO BE INSTALLED TO SECURE EACH FLOOR JOISTS (FJ).
5. HURRICANE CLIPS TO BE INSTALLED TO SECURE EACH ROOF RAFTER.
6. REFER TO DETAIL SHEETS FOR SHEAR WALL AND NAILING DETAILS.
7. REFER TO CONSTRUCTION NOTES ON A0.01 FOR ADDITIONAL INFORMATION
8. REFER TO STRUCTURAL DRAWINGS FOR FRAMING AND CONNECTIONS DETAILS
9. PILING TO BE CLASS B, 10" BUTT 8" HEAD MIN. W/ A CAPACITY OF 12 TONS THROUGHOUT.
10. ALL HEADERS ARE TO BE 2X10'S UNLESS OTHERWISE NOTED.
11. REAR DECKS ARE TO BE CONSTRUCTED W/ FIRE TREATED LUMBER AND TO BE FIRE SPRAYED.

WALL LEGEND

- NOTE: P.T. LUMBER REQUIRED AT ALL LOCATIONS BELOW D.F.E.
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KEYNOTES

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PROJECT TEAM:

SIGNATURE
CHRISTOPHER HALLIDAY
L1#21A101936000

SUBMITTAL INFO. / DATE

PROJECT INFORMATION: 2129

DATE: 05.05.2021
DRAWN BY: CMH
PROJECT
861-63 5th Street
Ocean City, NJ

PROJECT ADDRESS
861-63 5th Street
Ocean City, NJ
08226


OWNER CONTACT
861-867 Fifth Street LLC
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LOT AND BLOCK
Lot 23.02
Block 403

SHEET NUMBER AND NAME:

A3.02

Elevations



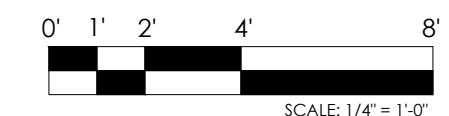

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CHRISTOPHER HALLIDAY

PROJECT INFORMATION: 2129

DATE: 05.05.2021 DRAWN BY: CMH
PROJECT:

861-63 5th Street
Ocean City, NJ

PROJECT ADDRESS
861-63 5th Street
Ocean City, NJ
08226



OWNER CONTACT:
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Ocean City NJ, 08226

Lot 23.02
Block 403

SHEET NUMBER AND NAME:

A6.02

Details

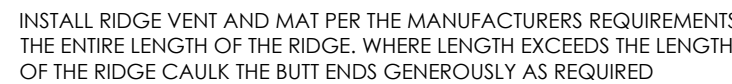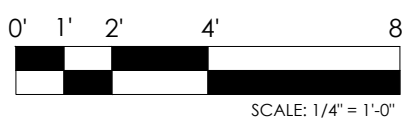


RIDGE VENT DETAIL

scale: 1 1/2" = 1'-0"



scale: NTS

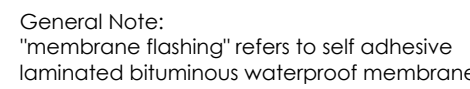


TYP. MEMBRANE FLASHING @ OPENINGS

SCALE: NTS **4**




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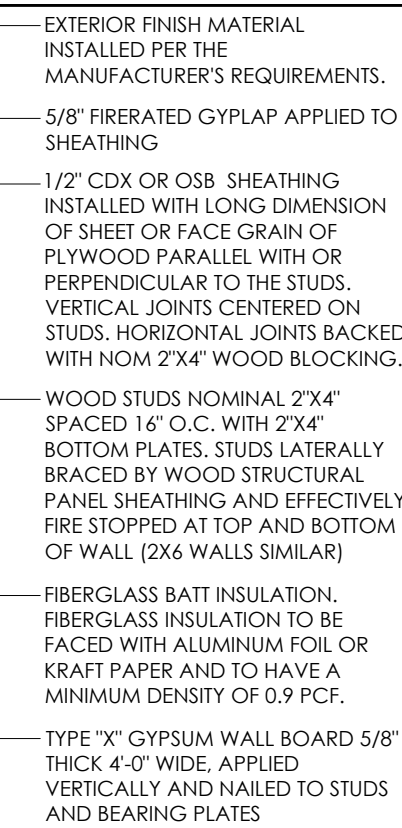

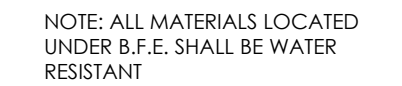
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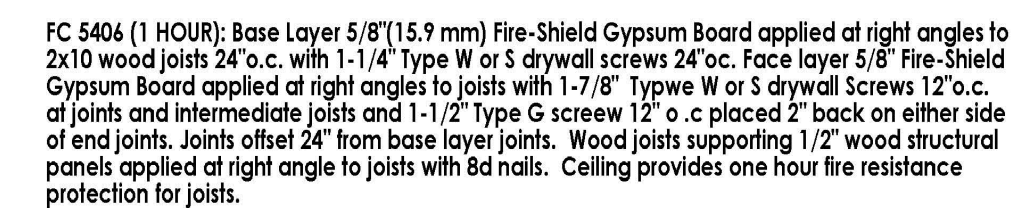
ASSEMBLY



scale: 1 1/2" - 1'-0" 



ALL MATERIALS LOCATED UNDER B.F.E.
BE WATER RESISTANT



1 HR. CEILING ASSEMBLY

scale: NTS






SCALE 1/4"=1'-0"




scale: 1 1/2" - 1'-0" (UL L583)




scale: 3" = 1'-0"

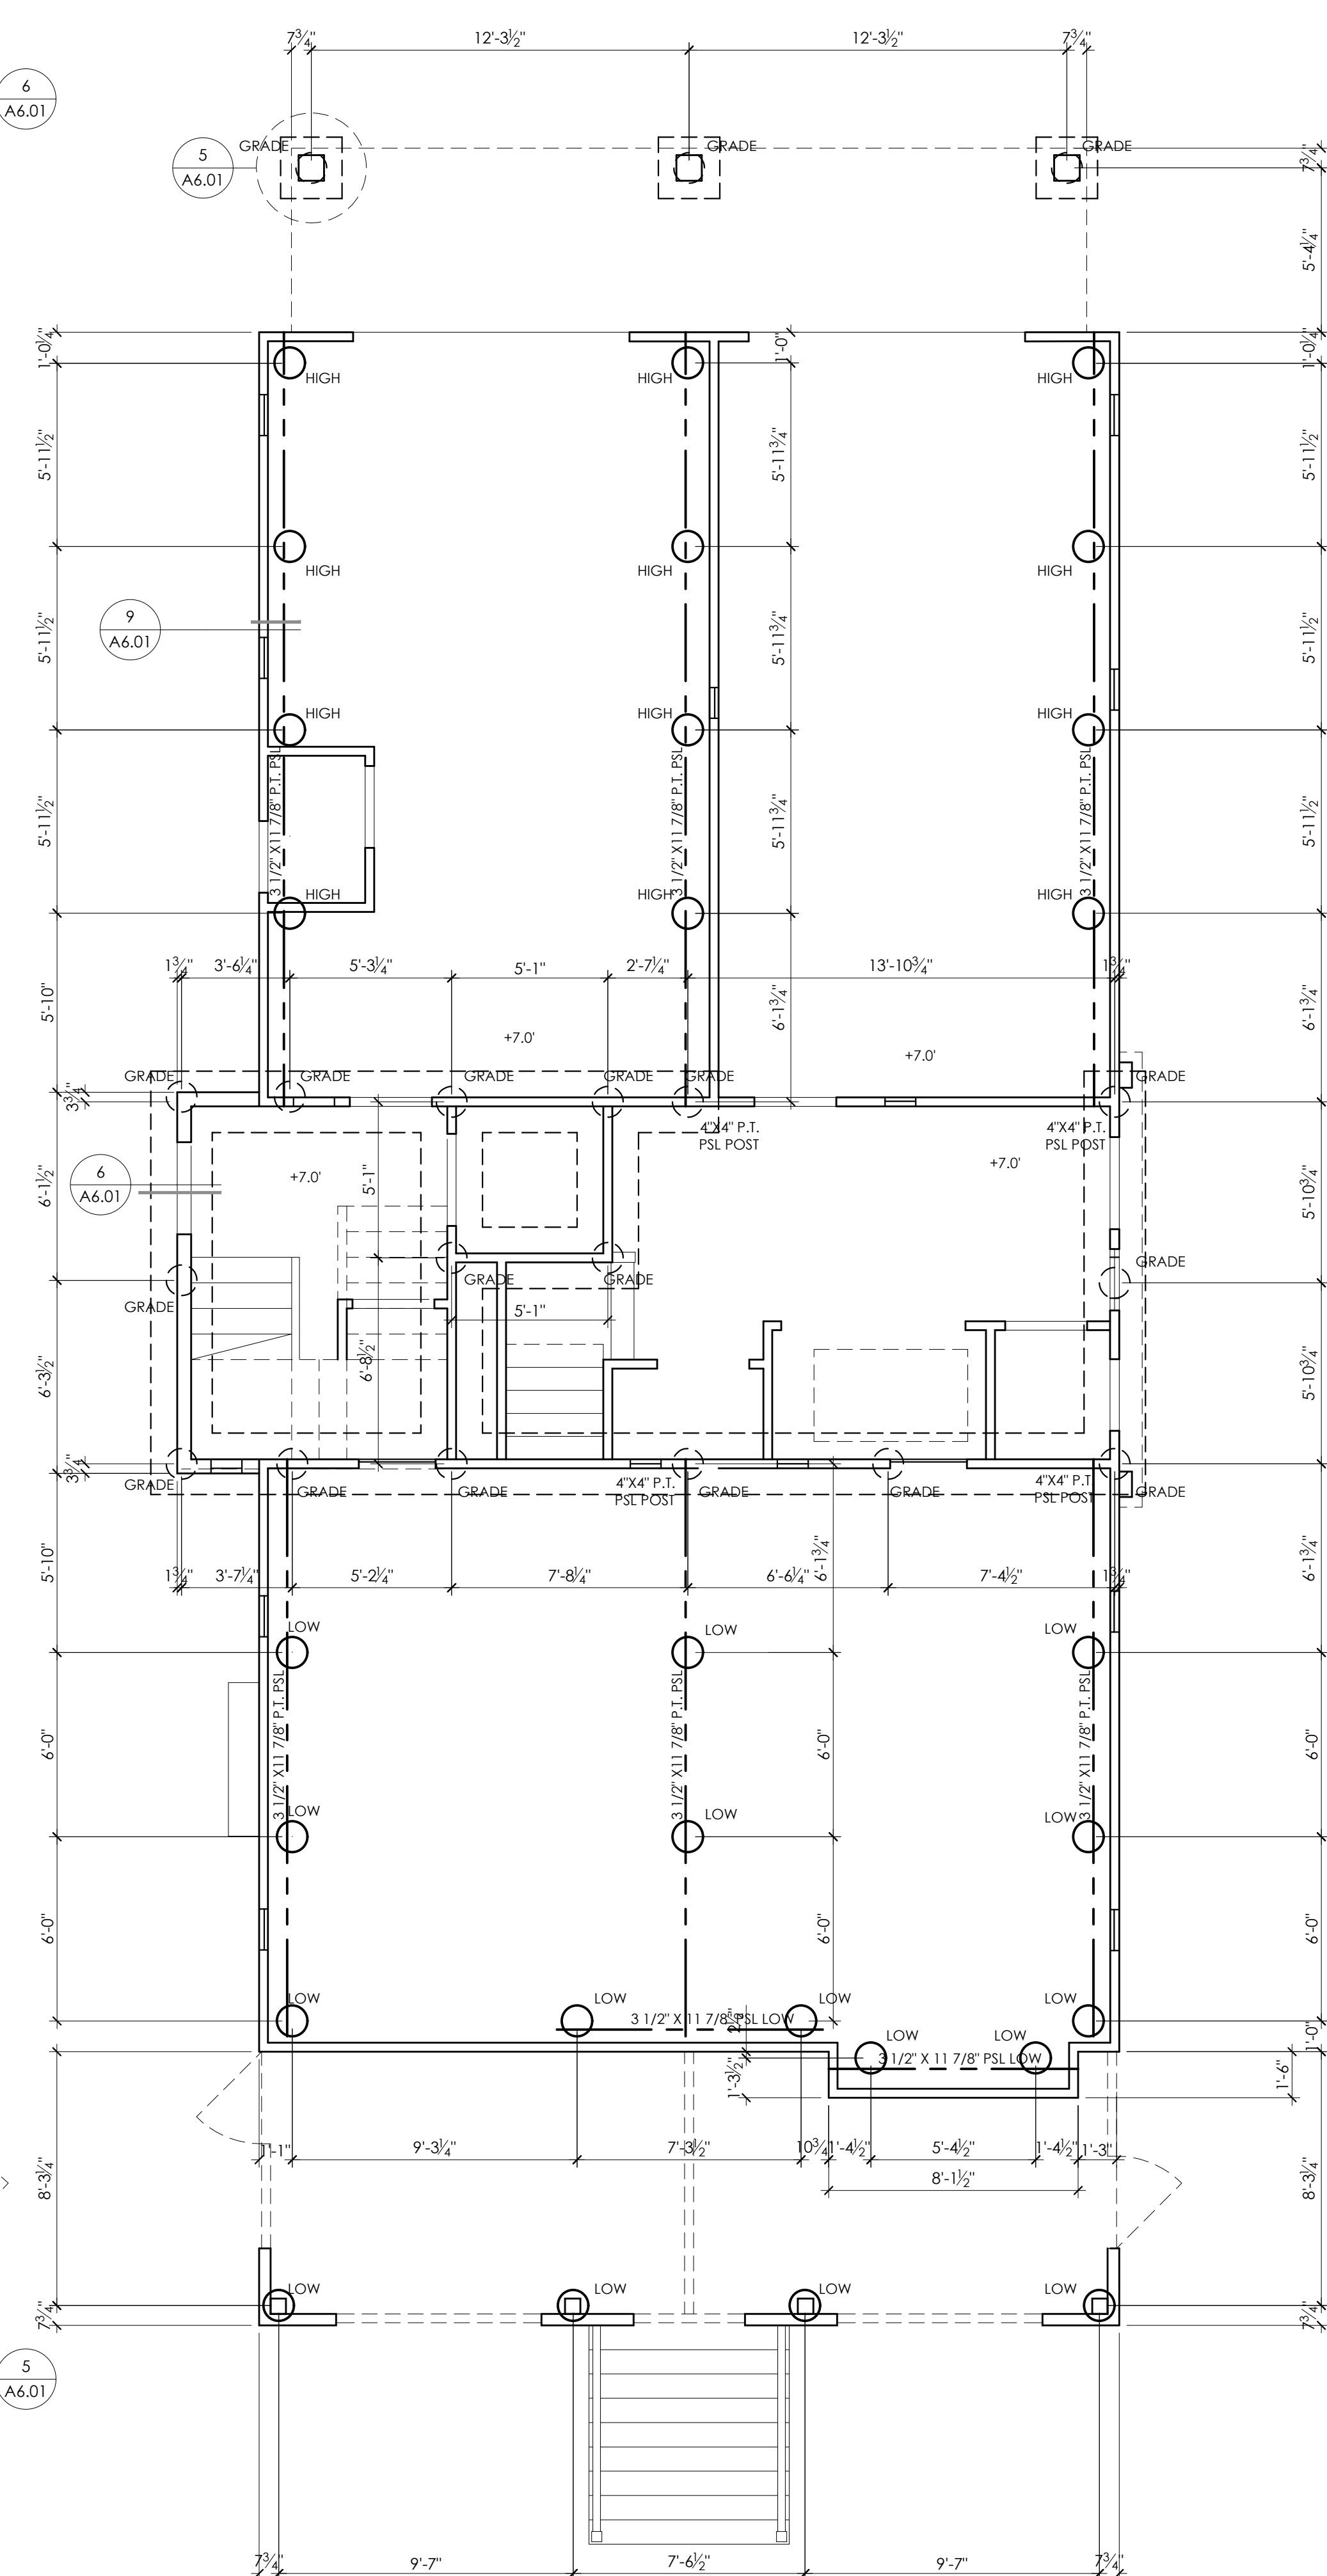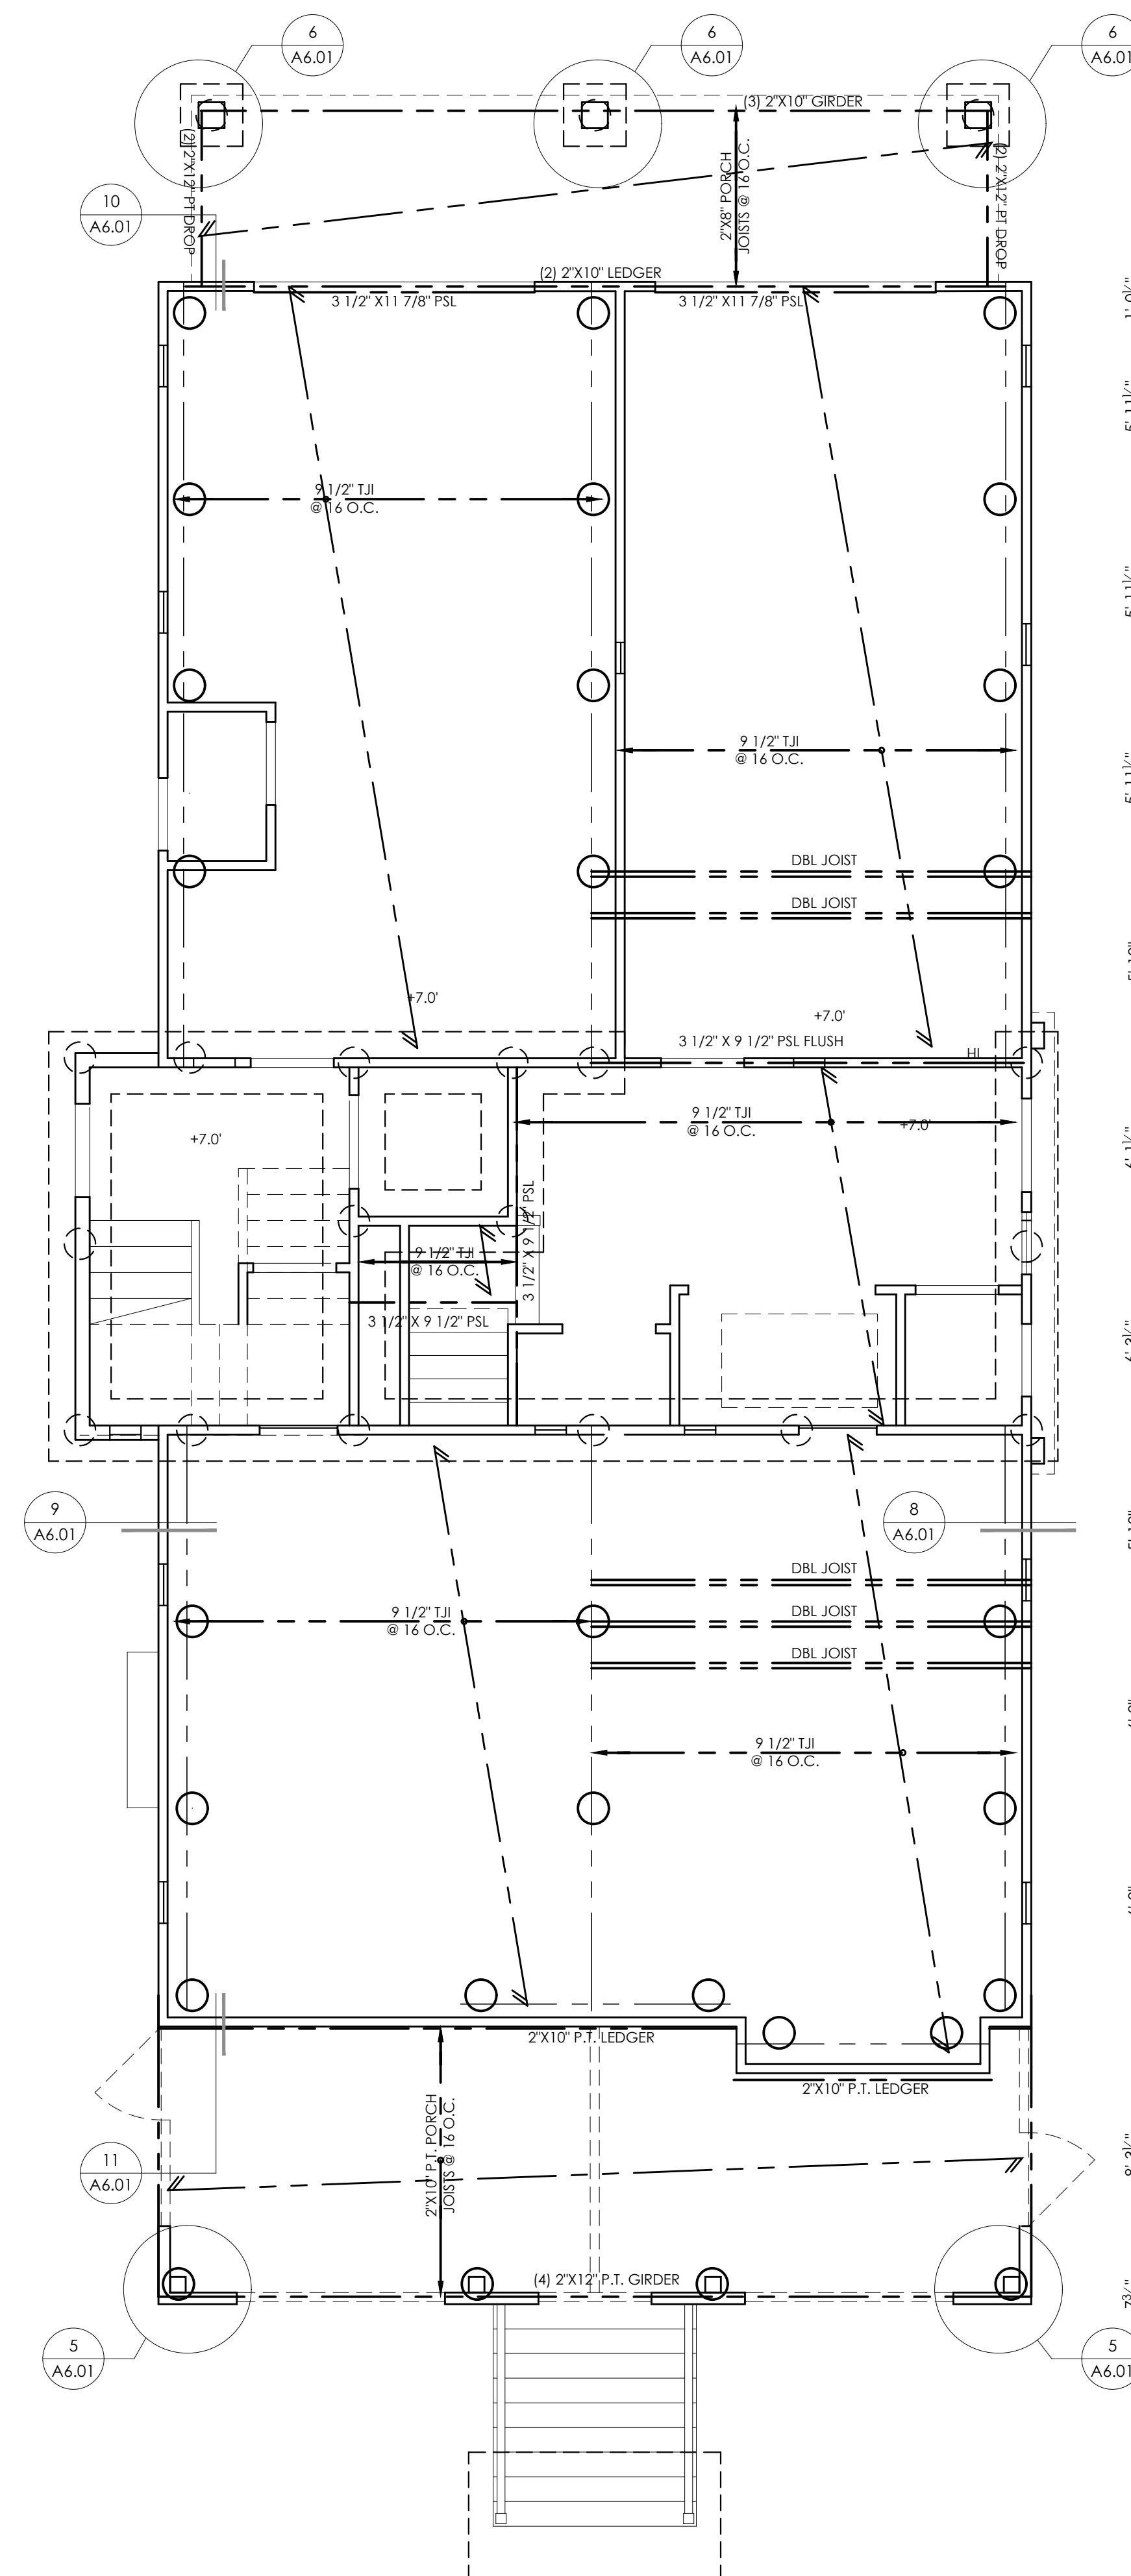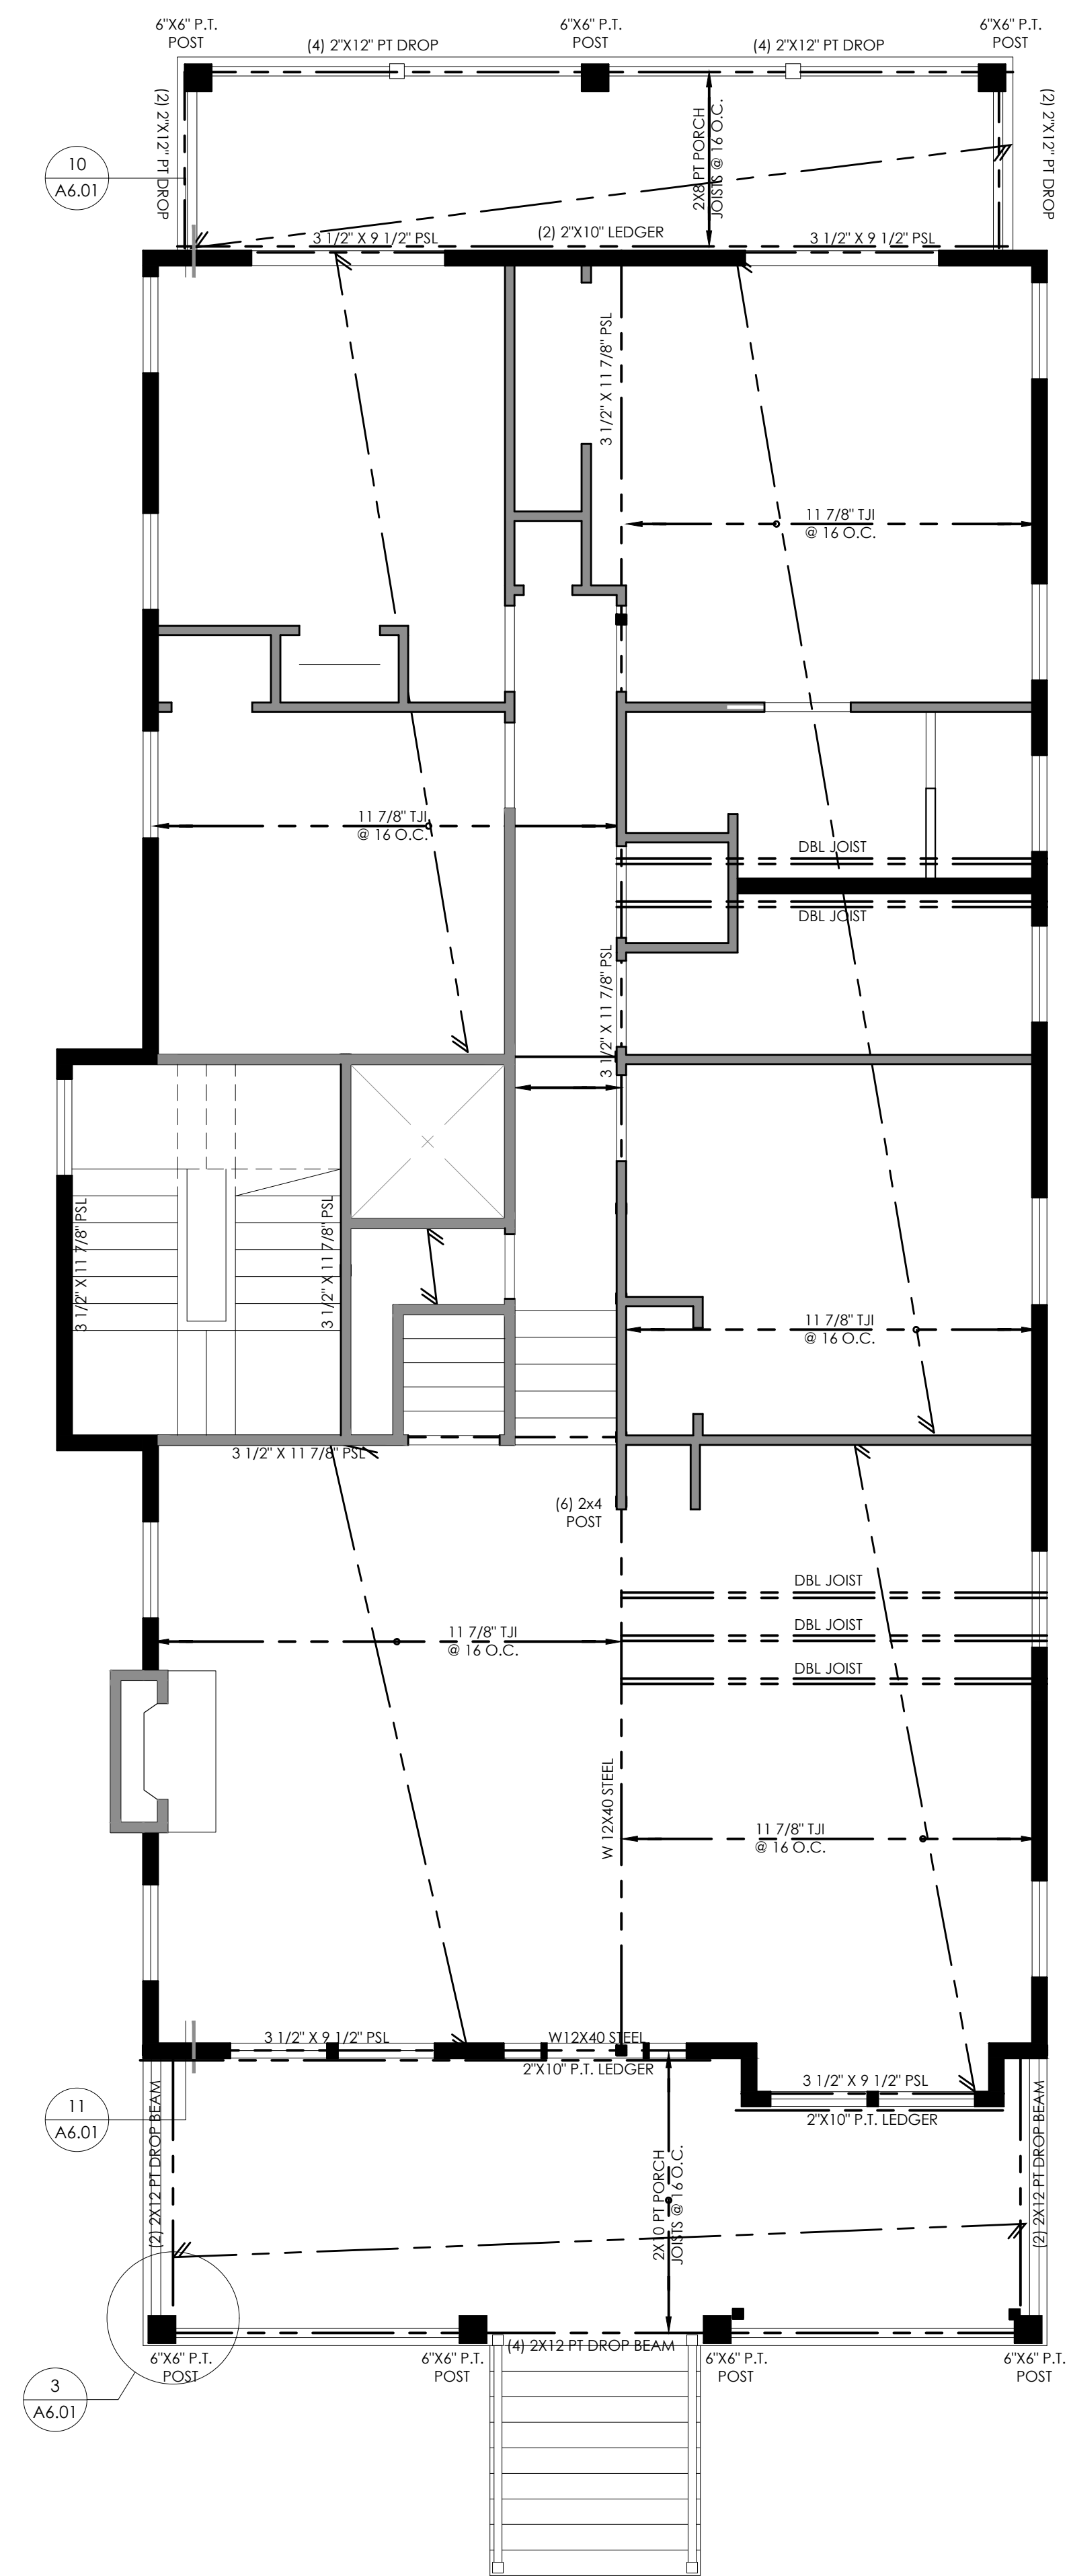

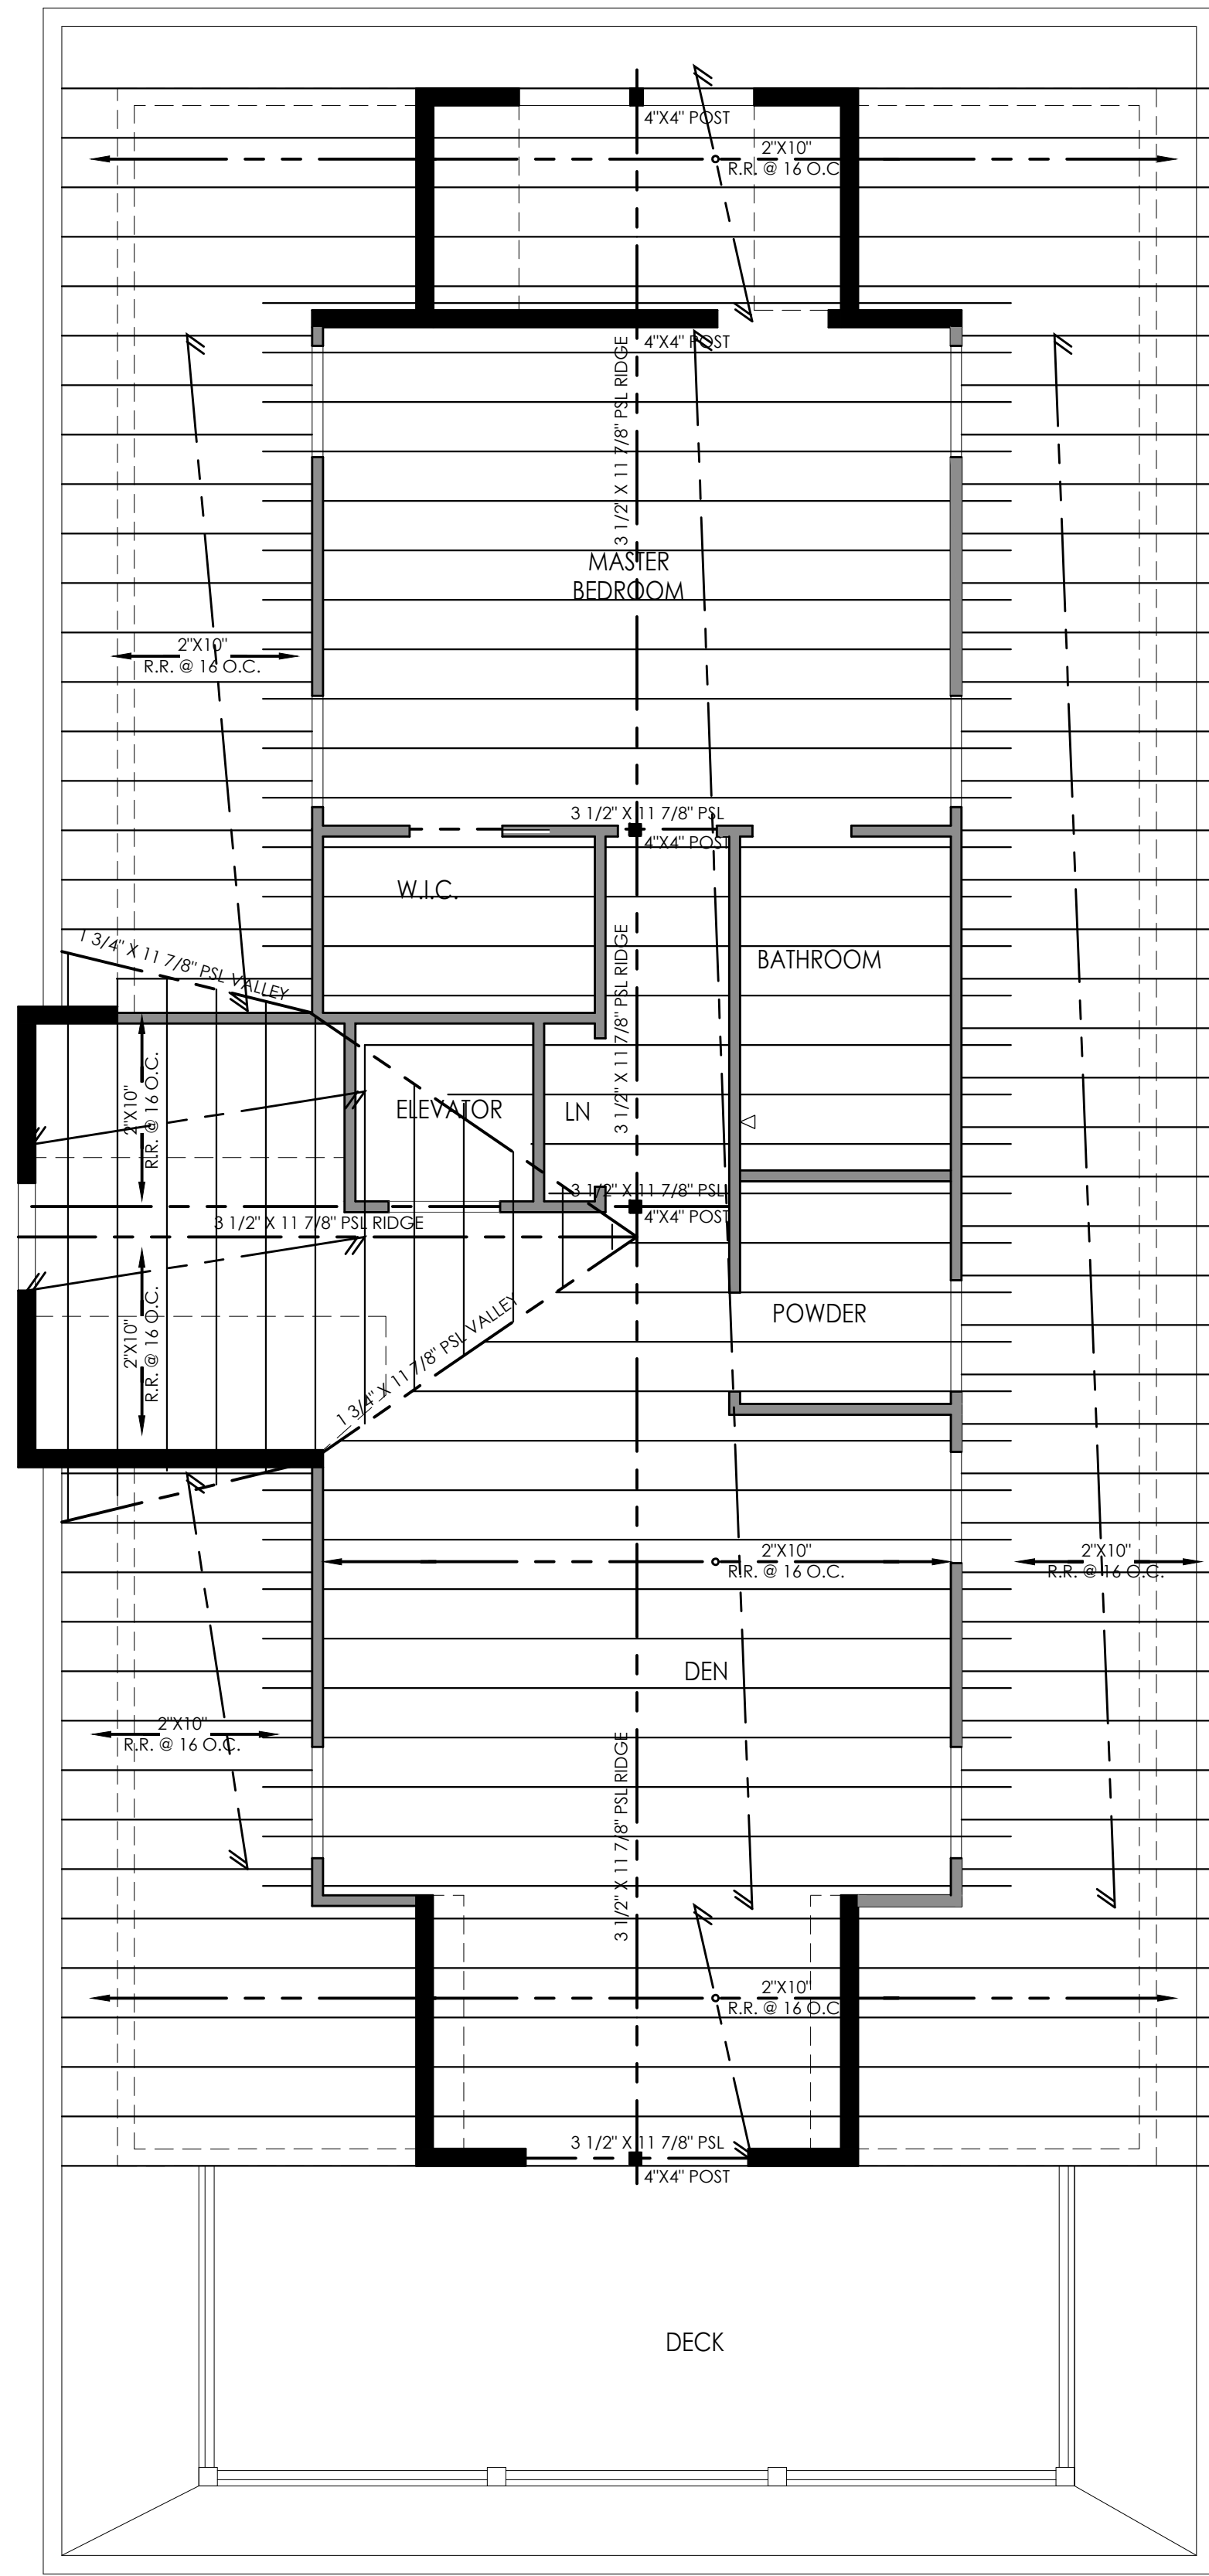

ROOF FRAMING PLAN
scale: 1/4" = 1'-0"

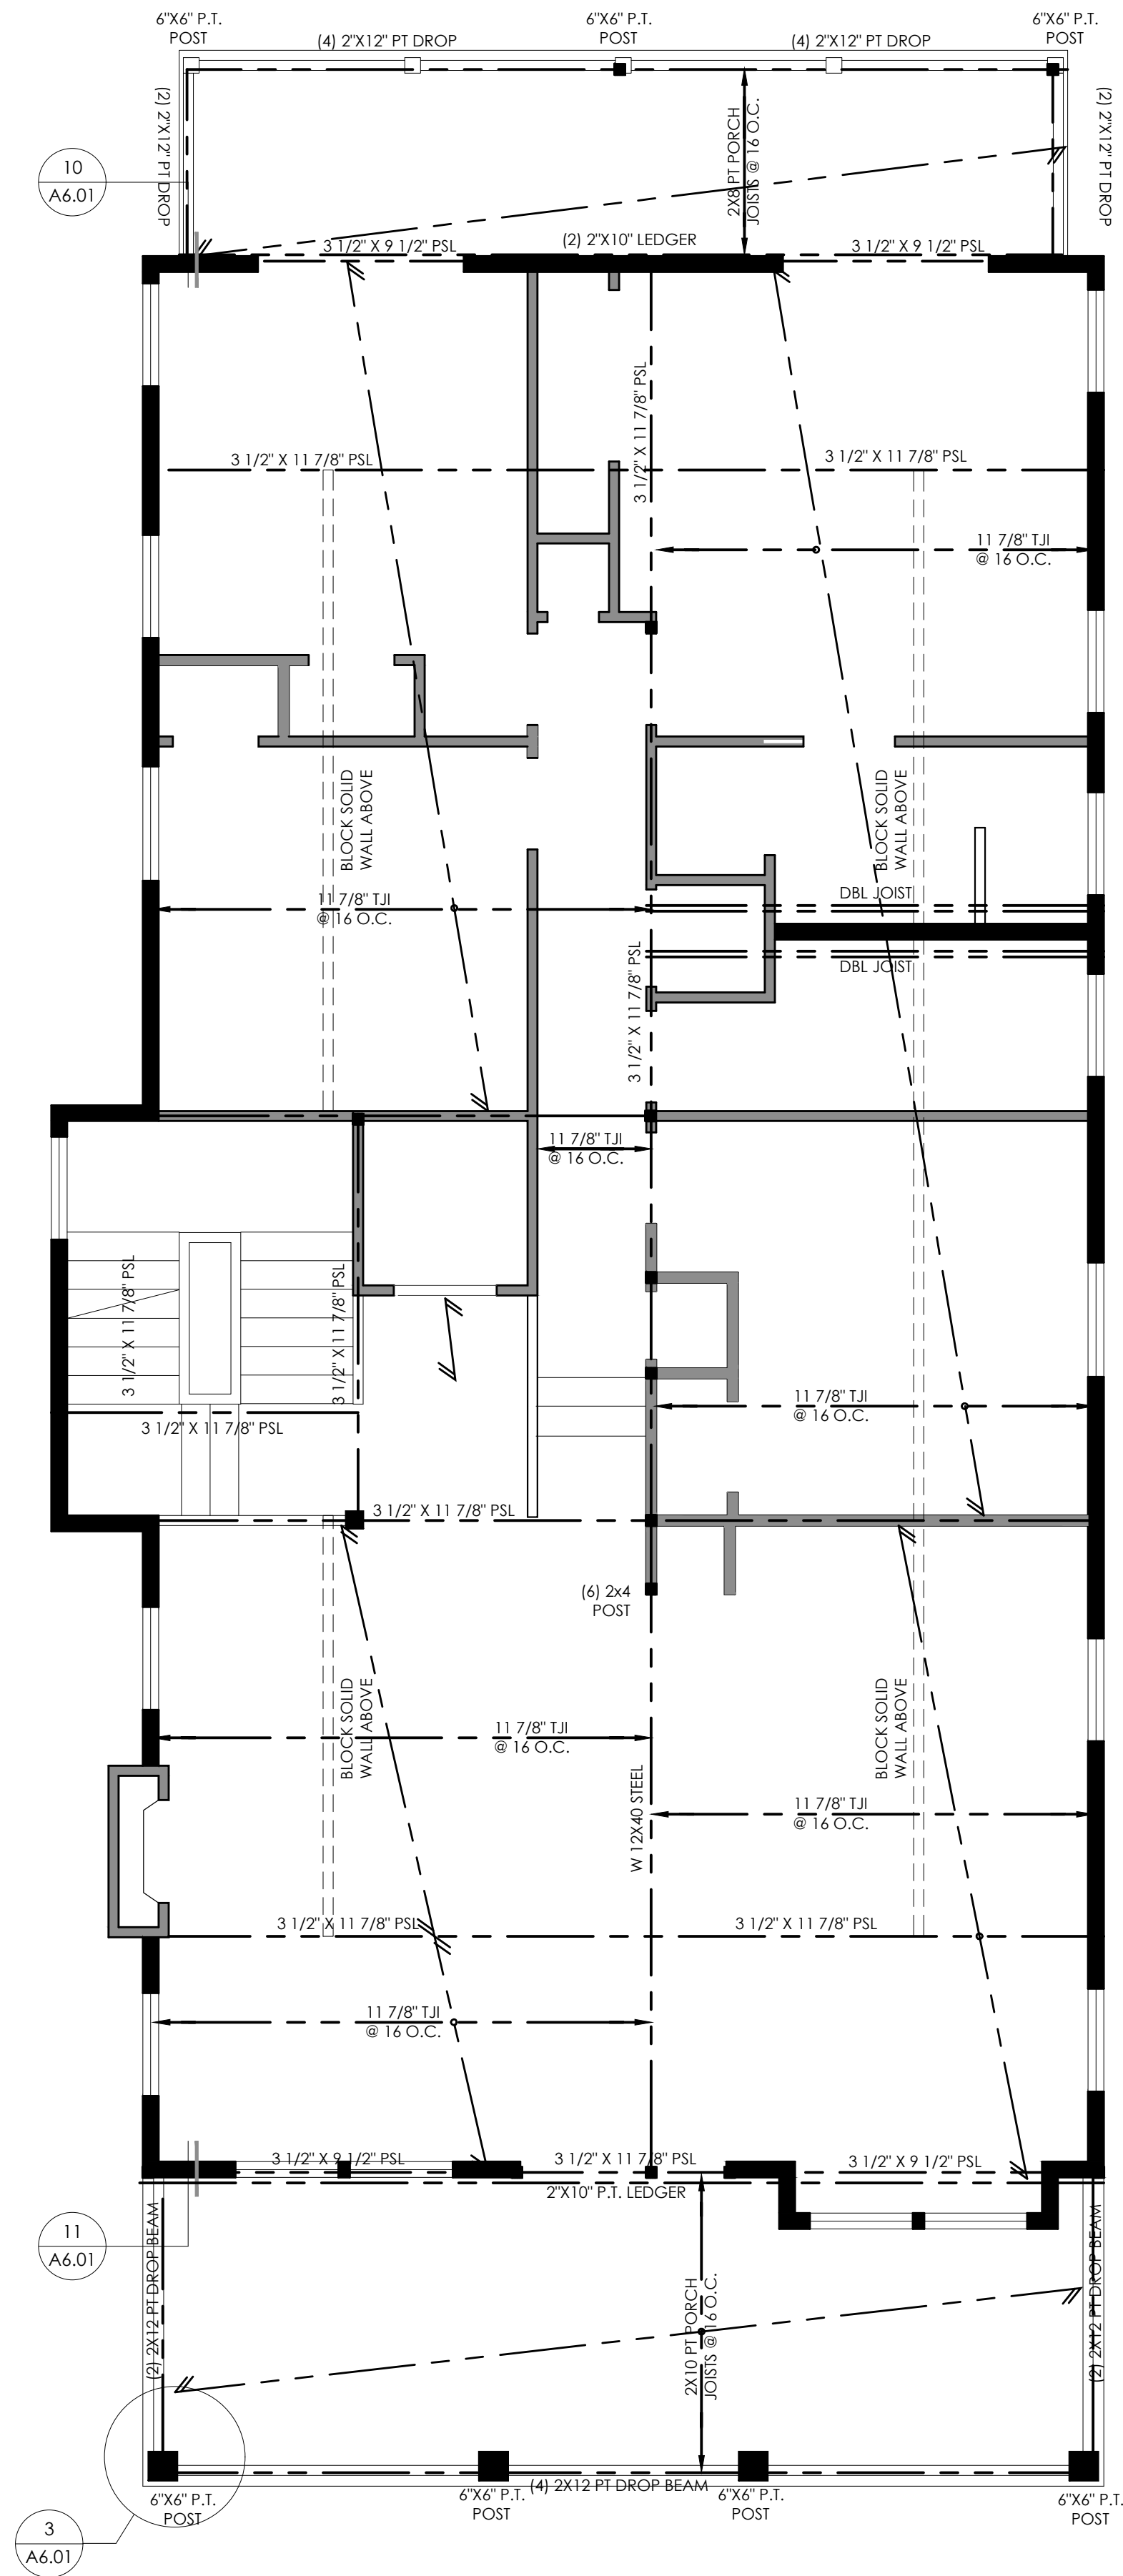

SECOND FLOOR FRAMING CEILING AND ROOF PLAN
scale: 1/4" = 1'-0"

FRONT SECOND FLOOR
DECK TO BE
CONSTRUCTED WITH
FIRE TREATED LUMBER

Halliday Architects

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PROJECT TEAM:

SIGNATURE
CHRISTOPHER HALLIDAY

LI#21A101936000

SUBMITTAL INFO. / DATE

PROJECT INFORMATION: 2129

DATE: 04.28.2021

DRAWN BY: CMH

PROJECT:

861-63 5th Street
Ocean City, NJ

PROJECT ADDRESS:

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Ocean City, NJ
08226

OWNER CONTACT:

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11 E 9th Street Suite 3
Ocean City NJ, 08226

LOT AND BLOCK:

Lot 23.02
Block 403

SHEET NUMBER AND NAME:

S.2

Attic Framing Plan +
Roof Framing Plan



SCALE: 1/4" = 1'-0"