| DC | DOOR SCHEDULE: | | | | | | | | | |
|------------|----------------|-------------|----------------|--------------------|--------|-----------|-----------|-------|-------------------|--|
| NO. | PAIR | WIDTH | HEIGHT | MATERIAL | FINISH | GLASS | MFR. | TINT | OPERATION | REMARKS |
| 001 | - | 28" | 6'-8" | AZEK | T.B.D. | - | T.B.D. | - | SWING | SHOWER DOOR TO FABRICATED BY G.C. (REFER TO EXTERIOR ELEVATIONS) |
| 002 | - | 36" | 6'-8" | FIBGLSS | T.B.D. | TEMP | T.B.D. | LOW-E | SWING | SIDE ENTRY DOOR |
| 003 | - | 32" | 6'-8" | FIBGLSS | T.B.D. | - | T.B.D. | - | SWING | |
| 004 | YES | 72" | 6'-8" | FIBGLSS | T.B.D. | - | T.B.D. | - | FRENCH | |
| 005 | YES | 36" | 6'-8" | FIBGLSS | T.B.D. | - | T.B.D. | - | FRENCH | |
| 006 | - | 32" | 6'-8" | FIBGLSS | T.B.D. | - | T.B.D. | - | SWING | |
| 007 | - | 36" | 6'-8" | FIBGLSS | T.B.D. | - | T.B.D. | - | SWING | SOLID CORE 1 HOUR FIRE RATED DOOR |
| 800 | - | 36" | 6'-8" | FIBGLSS | T.B.D. | TEMP | T.B.D. | LOW-E | SWING | |
| 009 | - | 32" | 6'-8" | FIBGLSS | T.B.D. | - | T.B.D. | - | SWING | SOLID CORE 1 HOUR FIRE RATED DOOR |
| 010 | - | 28" | 6'-8" | AZEK | T.B.D. | - | T.B.D. | - | SWING | SHOWER DOOR TO FABRICATED BY G.C. (REFER TO EXTERIOR ELEVATIONS) |
| 011 | - | 32" | 6'-8" | FIBGLSS | T.B.D. | - | T.B.D. | - | SWING | COURT CORE 1 HOUR FIRE DATED DOOR |
| 012 | - | 32" 108" | 6'-8" 7'-0" | FIBGLSS | T.B.D. | - | T.B.D. | - | SWING OVERHEAD | SOLID CORE 1 HOUR FIRE RATED DOOR GARAGE DOOR |
| 013 | - | 108" | 7'-0" | FIBGLSS FIBGLSS | T.B.D. | - | T.B.D. | - | OVERHEAD | GARAGE DOOR GARAGE DOOR |
| 014 | _ | 36" | 6'-8" | AZEK | T.B.D. | - | T.B.D. | - | SWING | (REFER TO EXTERIOR ELEVATIONS) |
| 016 | | 36" | 6'-8" | AZEK | T.B.D. | | T.B.D. | _ | SWING | (REFER TO EXTERIOR ELEVATIONS) |
| 101 | _ | 36" | 6'-8" | FIBGLSS | T.B.D. | TEMP | THERMATRU | LOW-E | SWING | 36" FRONT DOOR WITH 14" SIDE LITES AND TRANSOM ABOVE |
| 102 | _ | 24" | 6'-8" | MASONITE | | - | T.B.D. | - | SWING | |
| 103 | - | 34" | 6'-8" | MASONITE | | | T.B.D. | - | SWING | 1 HOUR FIRE RATED |
| 104 | - | 32" | 6'-8" | MASONITE | | - | T.B.D. | - | SWING | |
| 105 | - | 24" | 6'-8" | MASONITE | | - | T.B.D. | - | SWING | LOUVERED @ HWH |
| 106 | - | 32" | 6'-8" | MASONITE | | - | T.B.D. | - | SWING | |
| 107 | - | 32" | 6'-8" | MASONITE | T.B.D. | - | T.B.D. | - | SWING | |
| 108 | YES | 36" | 6'-8" | MASONITE | T.B.D. | - | T.B.D. | - | FRENCH | LOUVERED |
| 109 | - | 32" | 6'-8" | MASONITE | T.B.D. | - | T.B.D. | - | SWING | |
| 110 | - | 30" | 6'-8" | MASONITE | T.B.D. | - | T.B.D. | - | SWING | |
| 111 | - | 30" | 6'-8" | MASONITE | T.B.D. | = | T.B.D. | - | SWING | |
| 112 | - | 32" | 6'-8" | MASONITE | T.B.D. | - | T.B.D. | - | SWING | |
| 113 | - | 18" | 6'-8" | MASONITE | T.B.D. | - | T.B.D. | - | SWING | |
| 114 | - | 32" | 6'-8" | MASONITE | | - | T.B.D. | - | SWING | |
| 115 | - | 32" | 6'-8" | MASONITE | | - | T.B.D. | - | POCKET | |
| 116 | YES | 60" | 6'-8" | MASONITE | T.B.D. | - | T.B.D. | - | FRENCH | |
| 117 | - | 72" | 6'-8'' | VINYL | T.B.D. | TEMP | ANDERSEN | LOW-E | SLIDING | |
| 118 | - | 72" | 6'-8" | VINYL | T.B.D. | TEMP | ANDERSEN | LOW-E | SLIDING | |
| 201 | - | 72" 24" | 6'-8" | VINYL | T.B.D. | TEMP - | ANDERSEN | LOW-E | SLIDING | |
| 202 | - | 32" | 6'-8" 6'-8" | MASONITE | | - | T.B.D. | - | SWING SWING | |
| 203 | - | 24" | 6'-8" | MASONITE | | - | T.B.D. | - | SWING | LOUVERED |
| 204 | | 36" | 6'-8" | MASONITE | | | T.B.D. | - | SWING | 1 HOUR FIRE RATED |
| 206 | _ | 32" | 6'-8" | MASONITE | | | T.B.D. | _ | SWING | THOURTINE NATED |
| 207 | - | 32" | 6'-8" | MASONITE | | | T.B.D. | - | SWING | |
| 208 | YES | 36" | 6'-8" | MASONITE | | - | T.B.D. | - | FRENCH | |
| 209 | - | 32" | 6'-8" | MASONITE | | - | T.B.D. | - | SWING | |
| 210 | - | 30" | 6'-8" | MASONITE | | - | T.B.D. | - | SWING | |
| 211 | - | 32" | 6'-8" | MASONITE | T.B.D. | - | T.B.D. | - | SWING | |
| 212 | - | 30" | 6'-8" | MASONITE | T.B.D. | - | T.B.D. | - | SWING | |
| 213 | - | 18" | 6'-8" | MASONITE | T.B.D. | - | T.B.D. | - | SWING | |
| 214 | - | 32" | 6'-8" | MASONITE | T.B.D. | - | T.B.D. | - | SWING | |
| 215 | - | 32" | 6'-8" | MASONITE | | - | T.B.D. | - | POCKET | |
| 216 | YES | 60" | 6'-8" | MASONITE | T.B.D. | - | T.B.D. | - | FRENCH | |
| 217 | - | 72" | 6'-8" | VINYL | T.B.D. | TEMP | ANDERSEN | LOW-E | SLIDING | |
| 218 | - | 72" | 6'-8" | VINYL | T.B.D. | TEMP | ANDERSEN | LOW-E | SLIDING | |
| 301 | - | 72" | 6'-8" | VINYL | T.B.D. | TEMP | ANDERSEN | LOW-E | SLIDING | |
| 302 | YES | 48" | 6'-8" | MASONITE | | - | T.B.D. | - | SWING | |
| 303 | YES | 48" | 6'-8" | MASONITE | | - | T.B.D. | - | SWING | |
| 304 | - | 32" 36" | 6'-8" 6'-8" | MASONITE MASONITE | | - | T.B.D. | - | POCKET SWING | |
| 305 306 | <u> </u> | 36" | 6'-8" | MASONITE | | - | T.B.D. | - | SWING | 1 HOUR FIRE RATED (ELEVATOR DOOR) |
| 306 | - | 36" | 6'-8" | MASONITE | | - | T.B.D. | - | SWING | I HOUR TIKE KAILD (LLEVATOR DOOR) |
| 307 | - | 30" | 6'-8" | MASONITE | | - | T.B.D. | - | SWING | SOLID CORE |
| 309 | - | 36" | 6'-8" | MASONITE | | <u> </u> | T.B.D. | - | SWING | SOLID CORE |
| 308 | - | 30" | 6'-8" | MASONITE | | _ | T.B.D. | - | SWING | 1 |
| 309 | - | 30" | 6'-8" | MASONITE | | - | T.B.D. | - | SWING | |
| | | | | | | | | | | |

GENERAL CONTRACTOR TO SUBMIT A DOOR AND WINDOW ORDER SCHEDULE TO ARCHITECT FOR FINAL CONFIRMATION PRIOR TO ORDERING.

DOOR HARDWARE SHALL BE BUILDER STANDARD. REVIEW FINAL SELECTION W/ OWNER REFER TO DETAILS ON SHEET A6.02 FOR TYPICAL FLASHING DETAILS

206 36" 44" VINYL T.B.D. DBL PANE VIWINCO 6'-8" LOW-E DBL HUNG TEMPERED

CONTACT ARCHITECT IMMEDIATELY IF ANY DISCREPANCIES ARE IDENTIFIED.

WINDOW SCHEDIILE

| ۷۷۱۱ | וטטו | W 2CF | IEDULE: | | | | | | | |
|------|-------|--------|----------|--------|----------|---------|-------|-------|-----------|------------------------|
| NO. | WIDTH | HEIGHT | MATERIAL | FINISH | GLASS | MFR. | HEAD | TINT | OPERATION | REMARKS |
| 01 | 24" | 24" | VINYL | T.B.D. | DBL PANE | VIWINCO | 6'-8" | LOW-E | AWNING | |
| 101 | 36" | 60'' | VINYL | T.B.D. | DBL PANE | VIWINCO | 6'-8" | LOW-E | DBL HUNG | |
| 102 | 36" | 60'' | VINYL | T.B.D. | DBL PANE | VIWINCO | 6'-8" | LOW-E | DBL HUNG | TEMPERED |
| 103 | 36" | 36" | VINYL | T.B.D. | DBL PANE | VIWINCO | 6'-8" | LOW-E | AWNING | |
| 104 | 36" | 36" | VINYL | T.B.D. | DBL PANE | VIWINCO | 6'-8" | LOW-E | AWNING | |
| 105 | 36" | 60'' | VINYL | T.B.D. | DBL PANE | VIWINCO | 6'-8" | LOW-E | DBL HUNG | |
| 106 | 36" | 44'' | VINYL | T.B.D. | DBL PANE | VIWINCO | 6'-8" | LOW-E | DBL HUNG | TEMPERED |
| 107 | 40'' | 60'' | VINYL | T.B.D. | DBL PANE | VIWINCO | 6'-8" | LOW-E | DBL HUNG | EGRESS WINDOW |
| 108 | 36" | 24" | VINYL | T.B.D. | DBL PANE | VIWINCO | 6'-8" | LOW-E | AWNING | TEMPERED |
| 109 | 36" | 24" | VINYL | T.B.D. | DBL PANE | VIWINCO | 6'-8" | LOW-E | AWNING | TEMPERED |
| 110 | 36" | 44" | VINYL | T.B.D. | DBL PANE | VIWINCO | 6'-8" | LOW-E | DBL HUNG | |
| 111 | 36" | 44'' | VINYL | T.B.D. | DBL PANE | VIWINCO | 6'-8" | LOW-E | DBL HUNG | |
| 112 | 36" | 24" | VINYL | T.B.D. | DBL PANE | VIWINCO | 6'-8" | LOW-E | AWNING | |
| 113 | 36" | 24" | VINYL | T.B.D. | DBL PANE | VIWINCO | 6'-8" | LOW-E | AWNING | |
| 114 | 40" | 60" | VINYL | T.B.D. | DBL PANE | VIWINCO | 6'-8" | LOW-E | DBL HUNG | EGRESS WINDOW TEMPERED |
| 115 | 36" | 44" | VINYL | T.B.D. | DBL PANE | VIWINCO | 6'-8" | LOW-E | DBL HUNG | TEMPERED |
| 116 | 36" | 60'' | VINYL | T.B.D. | DBL PANE | VIWINCO | 6'-8" | LOW-E | DBL HUNG | |
| 117 | 36" | 60'' | VINYL | T.B.D. | DBL PANE | VIWINCO | 6'-8" | LOW-E | DBL HUNG | |
| 201 | 36" | 60'' | VINYL | T.B.D. | DBL PANE | VIWINCO | 6'-8" | LOW-E | DBL HUNG | |
| 202 | 36" | 60'' | VINYL | T.B.D. | DBL PANE | VIWINCO | 6'-8" | LOW-E | DBL HUNG | TEMPERED |
| 203 | 36" | 36" | VINYL | T.B.D. | DBL PANE | VIWINCO | 6'-8" | LOW-E | AWNING | |
| 204 | 36" | 36" | VINYL | T.B.D. | DBL PANE | VIWINCO | 6'-8" | LOW-E | AWNING | |
| 205 | 36" | 60" | VINYL | T.B.D. | DBL PANE | VIWINCO | 6'-8" | LOW-E | DBL HUNG | |

15' WIDE ALLEY PROPERTY LINE 40' PARKING SPACE GRASS W/-REQUIRED IRRIGATION ___ LINE OF DECK GRASS W/-REQUIRED IRRIGATION N) CONCRETE - AC CONDENSERS AC CONDENSERS— DRIVEWAY AND WALKWAY (N) HOSE BIB, -VERIFY LOCATION GRASS W/ W/OWNER REQUIRED IRRIGATION 26" WIDE-CONCRETE WAIKWAY PARKING OVER PARKING OVER _CONGRETE / CONCRETE (E) 9.0' ARCHITECTURAL -PROJECTION PREFERRED METER FIREPLACE-LOCATION(S) PROJECTION ABOVE UTILITIES TO BE CRAWISPACE OVER GRAVEL O CRAWLSPACE UNDERGROUND (N) HOSE BIB, -VERIFY LOCATION W/OWNER N) 18" ARCHITECTURAL PROJECTION N) FRONT PORCH ABOVE GRASS W/ - REQ/UIRED 🔎 · IRRIGATION_ (E) 8.5' PROPERTY LINE 40 (N)4" CONCRETE (N) HANDICAP RAMP — WITH RED-15 HANOVER
PAVERS REFER TO
(DETAIL 9/A6.02)

(N) TC = 8.23'
(E) GL = 7.73' (N) TC = 8.25'

NAVD 1988

PARK PLACE

CALIPER STREET \((N) 6" CONCRETE \((N) IRRIGATED \((E) ELECTRICAL \)

GRASS STRIP

(E) GL = 7.75'

UTILITY LINES

REFERENCE DATUM

SCALE: 1"=10' SITE PLAN WINDOW SCHEDULE (CONTINUED): NO. | WIDTH | HEIGHT | MATERIAL FINISH | GLASS | MFR. HEAD TINT OPERATION REMARKS 207 40" 60" VINYL T.B.D. DBL PANE VIWINCO 6'-8" LOW-E DBL HUNG EGRESS WINDOW 208 36" 24" VINYL T.B.D. DBL PANE VIWINCO 6'-8" LOW-E AWNING TEMPERED 209 36" 24" VINYL T.B.D. DBL PANE VIWINCO 6'-8" LOW-E AWNING TEMPERED 0 36" 44" VINYL T.B.D. DBL PANE VIWINCO 6'-8" LOW-E DBL HUNG VINYL T.B.D. DBL PANE VIWINCO 6'-8" LOW-E DBL HUNG VINYL T.B.D. DBL PANE VIWINCO 6'-8" LOW-E AWNING 213 36" 24" VINYL T.B.D. DBL PANE VIWINCO 6'-8" LOW-E AWNING 214 | 40" | 60" | VINYL | T.B.D. | DBL PANE | VIWINCO | 6'-8" | LOW-E | DBL HUNG | EGRESS WINDOW 215 | 36" | 44" | VINYL | T.B.D. | DBL PANE | VIWINCO | 6'-8" | LOW-E | DBL HUNG | TEMPERED 216 | 36" | 60" | VINYL | T.B.D. | DBL PANE | VIWINCO | 6'-8" | LOW-E | DBL HUNG 7 36" 60" VINYL T.B.D. DBL PANE VIWINCO 6'-8" LOW-E DBL HUNG 36" 24" VINYL T.B.D. DBL PANE VIWINCO 6'-8" LOW-E AWNING 02 36" 24" VINYL T.B.D. DBL PANE VIWINCO 6'-8" LOW-E AWNING 303 | 40" | 60" | VINYL | T.B.D. | DBL PANE | VIWINCO | 6'-8" | LOW-E | DBL HUNG | EGRESS WINDOW 304 36" 48" VINYL T.B.D. DBL PANE VIWINCO 6'-8" LOW-E DBL HUNG 305 36" 48" VINYL T.B.D. DBL PANE VIWINCO 6'-8" LOW-E DBL HUNG 306 36" 48" VINYL T.B.D. DBL PANE VIWINCO 6'-8" LOW-E DBL HUNG 007 30" 36" VINYL T.B.D. DBL PANE VIWINCO 6'-8" LOW-E DBL HUNG 308 36" 24" VINYL T.B.D. DBL PANE VIWINCO 6'-8" LOW-E AWNING TEMPERED 309 36" 24" VINYL T.B.D. DBL PANE VIWINCO 6'-8" LOW-E AWNING 10 36" 24" VINYL T.B.D. DBL PANE VIWINCO 6'-8" LOW-E AWNING \$\text{UPOL}\text{\frac{44"}{44"}} \ \ 18" \ VINYL \ T.B.D. \ DBL PANE \ VIWINCO \ 6'-8" \ LOW-E \ PICURE \$UPOLA 44" | 18" | VINYL | T.B.D. | DBL PANE | VIWINCO | 6'-8" | LOW-E | PICURE -\$UPOL\$\\ 44" | 18" | VINYL | T.B.D. | DBL PANE | VIWINCO | 6'-8" | LOW-E | PICURE UPOLA 44" | 18" | VINYL | T.B.D. | DBL PANE | VIWINCO | 6'-8" | LOW-E | PICURE

CONSTRUCTION NOTES

1. FLOOD VENT REQUIREMENTS: 1" OF FLOOD VENT PER S.F. ("SMART VENT" MODEL #1540-570 FLOOD VENTS, $8\frac{1}{2}$ "X14 $\frac{1}{2}$ ", PROVIDING COVERAGE FOR 200 SQUARE FEET).

Garage/Foyer: 1035 S.F. (6 VENT REQUIRED/ 6 VENTS PROVIDED) Crawlspace: 532 S.F. (3 VENTS REQUIRED/ 3 VENTS PROVIDED)

2. INSULATION REQUIRED AT FLOOR/CEILING, AND ALL EXTERIOR WALLS PER RES-CHECK DOCUMENT: WOOD FLOOR: R-30 CEILING: R-30 EXTERIOR WALLS: R-19

3. ALL EXTERIOR WALLS AND OVERHANGS WITHIN 5'-0" OF OF THE SIDE YARD SETBACKS TO HAVE 1 HR FIRE RATING WITH EXTERIOR GRADE TYPE "X" DRYWALL ON THE OUTSIDE OF THE SHEATHING AND TYPICAL TYPE "X" INTERIOR DRYWALL WHERE APPLICABLE (SEE PARTITION DETAIL).

4. G.C. IS TO REFER TO NOTES/ DETAILS ON SHEETS A6.01 FOR STRUCTURAL LOADS AND CONNECTION INFORMATION.

5. STAIR WELLS ARE TO BE CONSTRUCTED WITH 1 HOUR FIRE RATED WALLS (TYPICAL)

6. ALL WINDOWS IN STAIRWELLS AND WITHIN 60" OF PLUMBING HORIZONTALLY AND 36" VERTICALLY ARE TO BE TEMPERED.

7. ALL LUMBER LOCATED BELOW THE D.F.E. SHALL BE PRESSURE TREATED. ALL SHEATHING BELOW THE D.F.E. SHALL BE WATER RESISTANT PLYWOOD. ALL INTERIOR SHEATHING BELOW D.F.E. SHALL BE WATER RESISTANT FIBER CEMENT BOARDS. ALL INSULATION BELOW D.F.E. SHALL BE CLOSED CELL WATER RESISTANT/ MOLD RESISTANT INSULATION.

8. HOME IS TO BE CONSTRUCTED WITH ONE LEVEL FOR PARKING, LIMITED STORAGE AND BUILDING ACCESS AND TWO LEVELS OF LIVING ABOVE. UNDER THE SEPTEMBER 4, 2013 "GRADE LEVEL FLOOD ELEVATION MEMO," THIS STRUCTURE COMPLIES WITH THE VB CONSTRUCTION TYPE DEFINITION.

9.APPLIANCES AND GAS FIREPLACES ARE TO BE INSTALLED TO MEET MANUFACTURERS AND CODE REQUIREMENTS (WHICHEVER IS MORE STRINGENT).

1. ALL ELECTRICAL WORK TO CONFORM WITH THE 2017

2. ELECTRICAL CONTRACTOR SHALL VERIFY AND CHECK ALL

3. ELECTRICAL CONTRACTOR SHALL COORDINATE HIS WORK WITH THE ATLANTIC CITY ELECTRIC COMPANY AND SHALL COOPERATE WITH THEM IN DETERMINING LOADS, HOOKUPS,

4. CONTRACTOR SHALL PROVIDE SMOKE DETECTORS OR

5. ALL WIRE SHALL BE A MINIMUM NO 12. AWG TYPE THW COPPER RATED AT 75 DEGREES C. AND 167 DEGREES F.

(MIN 1/2" CONDUIT). HOME RUN CIRCUITS MORE THAN 75'

FROM PANEL BOARD SHALL BE NO. 10 AWF OR LARGER AS

6. ALL BATH AND POWDER ROOM OUTLETS SHALL BE GROUND

GROUND FAULT CIRCUIT INTERRUPT TYPE AND WEATHERPROOF

7. WHERE SWITCHES, RECEPTACLES AND OTHER OUTLETS ARE

STAGGERED TO PREVENT THE TRANSMISSION OF SOUND

A FIRE RATED WALL ASSEMBLY, LOCATE EACH OUTLET IN A

BOTH FACES OF FIRE RATED WALL IN A SINGLE STUD FACE

9. CIRCUIT THE LIGHTING AND RECEPTACLES ON DIFFERENT

AMP CIRCUIT, MAXIMUM 7 ON ANY 15 AMP CIRCUIT AND

PREWIRED DURING CONSTRUCTION WITH WALL OUTLETS.

SELECTED AND APPROVED BY OWNER/ ARCHITECT.

MAXIMUM 2 KITCHEN APPLIANCE RECEPTACLES ON ANY 20

CIRCUITS SO THAT EACH SPACE CONTAINS PARTS OF AT LEAST

10. PROVIDE A MAXIMUM OF 8 CONVENIENCE ON ANY ONE 20

11. CABLE TELEVISION, CAT5 AND TELEPHONE OUTLETS SHALL BE

12. ALL LIGHT FIXTURE SELECTIONS AND FINAL LOCATIONS TO BE

13. ALL RECESSED LIGHTS SHALL BE RATED FOR INSULATION

14. ELECTRICAL CONTRACTOR TO PROVIDE POWER AT HWH

AND HVAC EQUIPMENT PER EQUIPMENT MANUFACTURERS

16. ALL SMOKE DETECTORS ARE TO BE HARDWIRED 110V

AND FIXTURES ON THE JOB SITE WITH THE GENERAL

CONTRACTOR, ARCHITECT AND OTHER TRADES.

SHOWN BACK TO BACK IN INTERIOR PARTITIONS, THEY SHALL BE

THROUGH THE PARTITION. WHEN OUTLETS ARE BACK TO BACK IN

SEPARATE AND AND ADJACENT STUD TO AVOID OPENINGS IN

(ALWAYS FOLLOW FIRE RATED PARTITION ASSEMBLY GUIDELINES)

8. DO NOT SCALE DRAWINGS. VERIFY LOCATION OF EQUIPMENT

FAULT CIRCUIT INTERRUPT TYPE. EXTERIOR OUTLETS SHALL BE

RECOMMENDED BY THE MANUFACTURER AND/ OR AS SHOWN

ON THE PLANS. SMOKE DETECTORS TO BE WIRED SO THE SIGNAL

CONTRACTOR TO PROVIDE CONDUIT WHERE REQUIRED BY MEC

APPROVED DESIGN IN EACH LEVEL IN LOCATION AS

CONDITION AND EQUIPMENT PRIOR TO BEGINNING WORK AND

NATIONAL ELECTRICAL CODE'S LATEST REVISION.

ELECTRICAL NOTES

REPORT ANY DISCREPANCIES.

TEMPORARY SERVICES, ECT.

IS RELAYED TO ALL LOCATIONS.

REQUIRED.

TWO CIRCUITS.

AMP CIRCUIT.

CONTACT.

GUIDELINES.

PROJECT DATA

817 Park Place Project address: Ocean City, NJ 08226 2018 International Residential Code:

Code, New Jersey Edition Use Group: Construction Type: VA

Flood Zone: Base Flood Elevation: 9'-0" BFE Zoning Flood Elevation: 12'-0" Z.F.E.

Average Grade Calc: 9'+9'+9'+9'=36'/4=9' average grade

Corinthian R-2 Neighborhood Zones Block

817 Park Place LLC

Elevation Height 34' ABOVE 12'-0" Z.F.E. Lot Square Footage 4,000 sf 1,484 / 4,000 = 37% (40% ALLOWED) Coverage Impervious Coverage 2,600 / 4,000 = 65%

Ground Floor SF 673 sf Garage Foyer(s) 362 sf Crawspace

Ground Fl. Total: 1,567 st First Floor SF Living Area 1,484 sf Covered Porches 439 sf 1st Fl. Total: 1,923 sf Second Floor SF Living Area 1,484 sf

439 sf 2nd Fl. Total: 1,923 sf 740 sf Attic Floor SF Living Area 250 sf

2nd Fl. Total: 990 sf Attic Half Story: 50% 740 sf / 1,484 sf (49.8%)

1,838 sf Percentage under 4/12 (0%) Cupola 54 sf/ 1,838 sf=3%

Total Building Volume: Ground Floor: 13,888 cubic feet 19,230 cubic feet First Floor: Second Floor: 19,230 cubic feet 10,506 cubic feet

Total: 62,854 cubic feet

SHEET INDEX

ARCHITECTURAL DRAWINGS

Title Sheet/ Project Data/ Door and Window Schedule A1.01 Ground and First Floor Plans A1.02 Second Floor and Attic Floor Plans

Roof Plan Ground + First Floor Reflected Ceiling Plan Second Floor + Attic Reflected Ceiling Plan

Front Elevation and Side Elevation A3.02 Rear Elevation and Side Elevation A6.01 Details

A3.01

A6.02 Details Ground and First Floor Framing Plan Framing Plan

MECHANICAL NOTES:

. ALL DUCTWORK TO BE LOCATED ABOVE D.F.E. (+11.0') FIRST FLOOR DUCTWORK TO BE LOCATED IN GARAGE/ CRAWLSPACE CEILING. IF CRAWLSPACE DUCTWORK DROPS BELOW D.F.E. WATER PROOFING IS REQUIRED. SECOND FLOOR DUCTWORK TO BE LOCATED IN SECOND FLOOR

ATTIC AREA. 2. MECHANICAL EQUIPMENT TO BE LOCATED ABOVE D.F.E.

ELEVATION. IF DUCTS ARE LOCATED BELOW D.F.E. THEY ARE REQUIRED TO BE WATER PROOF.

3. ALL EXTERIOR VENTS ARE TO BE RUN TO EXTERIOR SOFFIT OR ROOF WHERE POSSIBLE.

4. EACH CONDO UNIT IS TO HAVE AN INDEPENDENT HVAC SYSTEM ONE LOCATED IN THE SECOND FLOOR ATTIC AND ONE LOCATED IN GARAGE.

5. ALL MECHANICAL WORK IS TO COMPLY WITH THE 2018 INTERNATIONAL MECHANICAL CODE

6. FIREPLACE IS TO BE DIRECT VENT TYPE (TO BE SELECTED BY OWNER)

PLUMBING NOTES:

1. ALL FIXTURES AND FINISHES ARE TO BE APPROVED BY OWNER PRIOR TO THE INSTALLATION.

2. PLUMBER TO INSTALL ALL PLUMBING PER THE 2018 NATIONAL STANDARD PLUMBING CODE

3. ALL PLUMBING LOCATED IN UNCONDITIONED SPACES ARE TO BE INSULATING

4. APPLIANCES AND GAS FIREPLACES ARE TO BE INSTALLED TO MEET MANUFACTURERS AND CODE REQUIREMENTS (WHICHEVER IS MORE STRINGENT).

Halliday Architects

Architect: Christopher Halliday email: chris@hallidayarchitects.com Tel: 609.957.6789 Address: P.O. Box 186 Ocean City, NJ 08226

All of the drawings and documents within these sheets are under the ownership of Halliday Architects and are for the sole use of the construction of the pertaining project. They are not to be traced, copied, scanned, reprinted, reproduced, or otherwise used without the expressed and written consent of Halliday Architects

PROJECT TEAM:

SIGNATURE

CHRISTOPHER HALLIDAY

LI#21AI01936000

SUBMITTAL INFO./ DATE

PROJECT INFORMATION: 2187

DATE: 11.23.2021 DRAWN BY: CMH | PROJECT | 817-819 Park Place

Ocean City, NJ

[PROJECT ADDRESS] 817-819 Park Place Ocean City, NJ

OWNER CONTACT

817-19 Park Place, LLC


11 E 9th Street Suite 3 Ocean City NJ, 08226

| LOT AND BLOCK | Lot 47

Block 302 SHEET NUMBER AND NAME:

Title Sheet

Code Information Door and

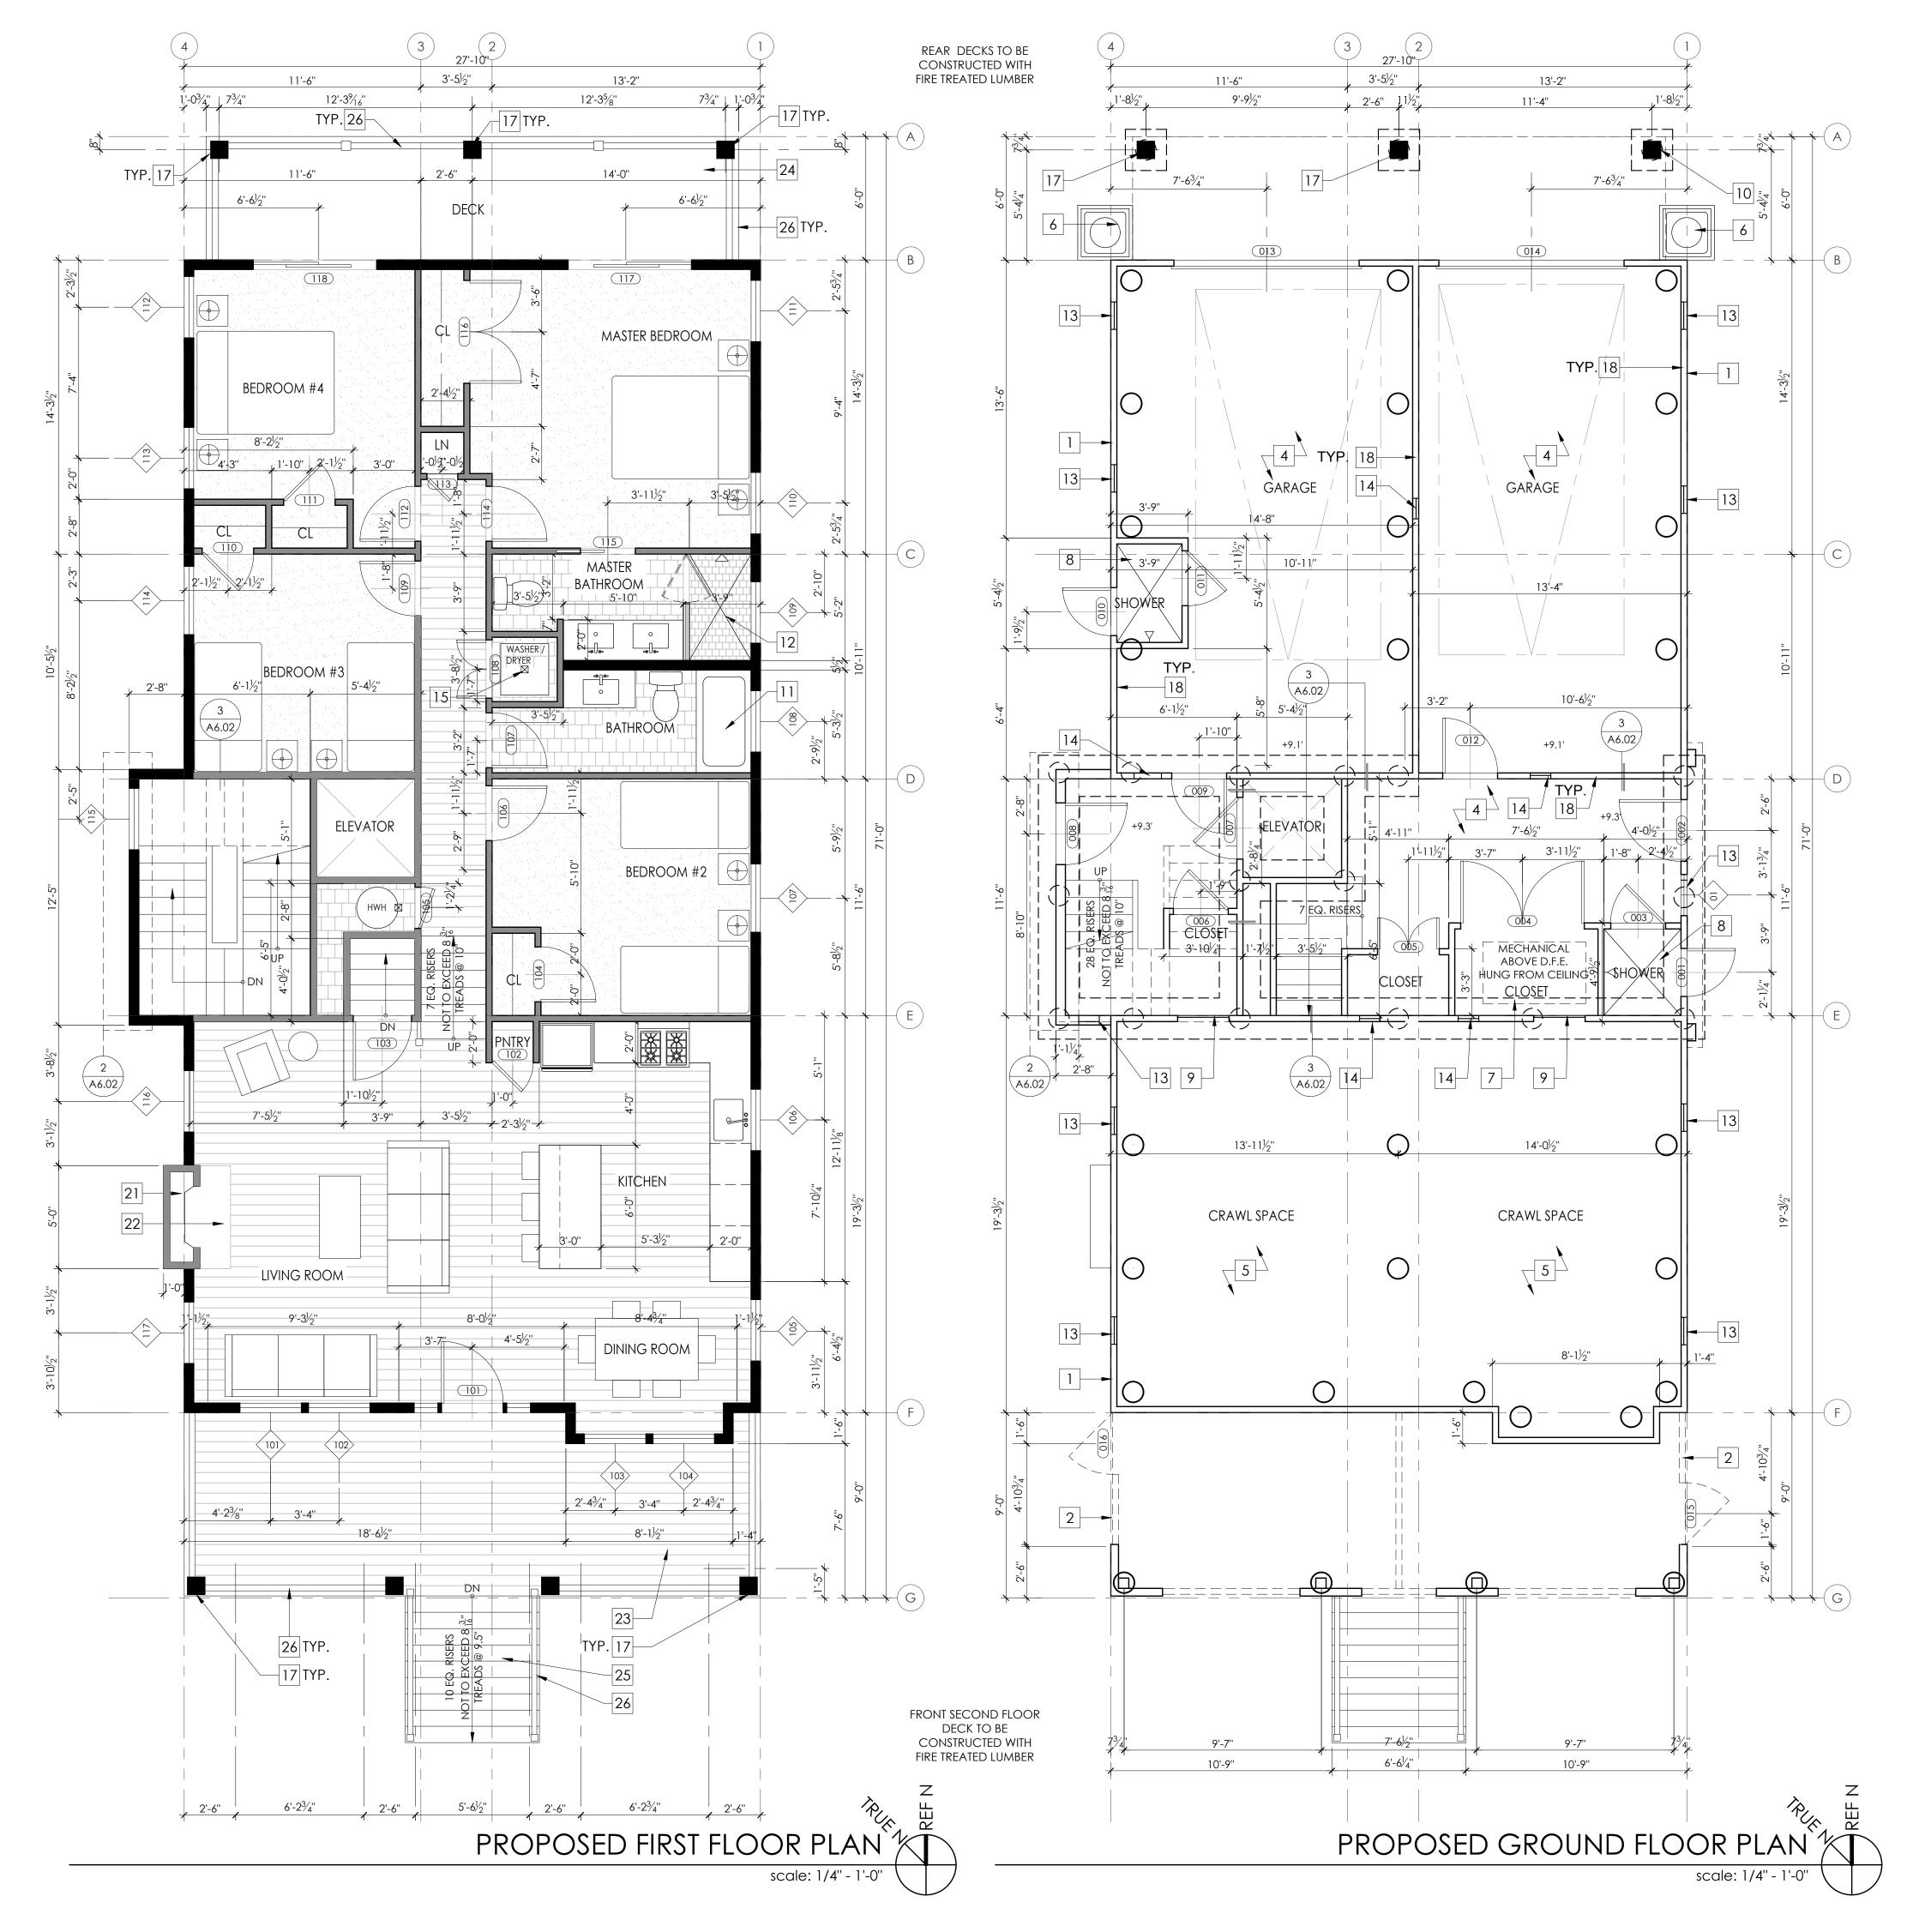

X 3 1/2" DBL JACKS.

1. DIMENSIONS ARE TO FACE OF FRAME UNLESS NOTED

2. DIMENSIONS WITH "CLR" ARE FINISH DIMENSIONS REQUIRED BY CODE

BY CODE.

3. ALL EXTERIOR WINDOWS AND DOORS ARE TO BE INSTALLED

WITH (2) 2X10 BUILT UP STRUCTURAL HEADER BEARING ON 3 1/2"

4. HURRICANE CLIPS TO BE INSTALLED TO SECURE EACH FLOOR

5. HURRICANE CLIPS TO BE INSTALLED TO SECURE EACH ROOF

6. REFER TO DETAIL SHEETS FOR SHEAR WALL AND NAILING

7. REFER TO CONSTRUCTION NOTES ON A0.01 FOR ADDITIONAL

INFORMATION

5. SEE SHEETS A6.01 AND A6.02 FOR DETAILS

6. REFER TO STRUCTURAL DRAWINGS FOR FRAMING AND CONNECTIONS DETAILS

7. PILING TO BE CLASS B, 10" BUTT 8" HEAD MIN. W/ A CAPACITY OF 12 TONS THROUGHOUT.

8. ALL HEADERS ARE TO BE 2X10'S UNLESS OTHERWISE NOTED.

9. REAR DECKS ARE TO BE CONSTRUCTED W/ FIRE TREATED LUMBER AND TO BE FIRE SPRAYED.

WALL LEGEND

NOTE: P.T. LUMBER REQUIRED AT ALL LOCATIONS BELOW D.F.E.

(N) 2X6 EXTERIOR LOAD BEARING WALL. P.T. LUMBER REQUIRED BELOW D.F.E.

(N) 2X4 INTERIOR NON LOAD BEARING WALL

KEYNOTES

- (N) SMOOTH TROWELED STUCCO FINISHED WALL AT GARAGE AND CRAWLSPACE. REFER TO EXTERIOR
- ELEVATIONS.

 (N) VARYING WIDTH 4" AND 6" AZEK BOARD SCREENING UNDER DECK
- 3 (N) CONCRETE SLAB ON GRADE W/ VISQUIM MESH
- (N) 4" THICK STRUCTURAL CONCRETE SLAB, TO BE POURED ON COMPACTED FILL W/ 6MM VISIQUIM

 [5] (N) GRAVEL
- 6 (N) A.C. CONDENSER UNIT
- 7 (N) HVAC UNIT SUSPENDED FROM CEILING ABOVE
- 8 (N) OUTDOOR SHOWER ENCLOSURE WITH COMPOSITE DECKING FLOOR OVER GRAVEL WITH FRENCH DRAIN
- 9 (N) CRAWLSPACE ACCESS PANEL
- (N) 6"X6" 1 HR FIRE TREATED STRUCTURAL POST WRAPPED WITH AZEK
- 11 (N) 5'-0" FIBERGLASS SHOWER/TUB INSERT
- (N) TILED SHOWER WITH FIBERGLASS PAN AND GLASS DOOR/ENCLOSURE
- FLOOD VENT: "SMART VENT" MODEL #1540-520, 8 $\frac{1}{2}$ "X14 $\frac{1}{2}$ ", PROVIDING COVERAGE FOR 200 SQUARE FEET EA.
- 14 (N) INTERIOR SCREEN VENT
- 15 (N) FLOOR DRAIN
- (N) CERTAINTEED TRIPLE 5" STRAIGHT EDGE SAWMILL SHINGLES (COLOR TO BE SELECTED BY OWNER)
- (N) 10" SQUARE FLAT FIBERGLASS COLUMN WITH BASE
- AND CAP PER THE ELEVATIONS, OVER 6"X6" P.T. POST
- (N) WATER RESISTANT GYP. BOARD BELOW Z.F.E. (@ GARAGE AND CRAWL SPACE INTERIOR))
- 19 ASPHALT SHINGLE ROOF. COLOR T.B.D.
- 20 GUTTER/DOWNSPOUT, COLOR T.B.D.
- 21 GAS FIREPLACE TO BE SELECTED BY OWNER
- 22 NON-COMBUSTIBLE FIREPLACE HEARTH
- COMPOSITE DECKING SECURED TO DECK STRUCTURE, SLOPE AWAY FROM HOUSE @ 2% MIN, COLOR T.B.D.

 (N) FIBERGLASS DECK COATING, SLOPE AWAY FROM HOUSE. (FRAMING TO BE TREATED/ DECKING TO BE FIRE
- SPRAYED)

 (N) EXTERIOR STAIR TO HAVE 4X4 POSTS (WHERE REQUIRED) W/ 2X12 STRINGERS @ 12" O.C.
- 26 STAIR/DECK GUARDRAIL, 36" MIN. WHITE VINYL FINISH
- EXTERIOR WALL SCONCE, REFER TO REFLECTED CEILING / POWER PLANS ON A2.01 + A2.02
- PULL DOWN ATTIC STAIR/LADDER, CONTRACTOR TO COORDINATE WITH OPENING WITH FRAMING

 CERTAINTEED 5" SHIPLAP SIDING (COLOR TO BE SELECTED BY OWNER)
- 30 BRICK VENEER OVER PRESSURE TREATED PLYWOOD
- VERTICAL BEADBOARD PVC SHIPLAP CUPOLA WITH STANDING SEAM METAL ROOF
- 32 10" PILLAR COLUMN WITH STANDING SEAM ROOF
- 33 PVC PANELLING PER ELEVATION
- CERTAINTEED BOARD AND BATTEN SIDING (COLOR TO BE SELECTED BY OWNER)



Halliday Architects

Architect: Christopher Halliday email: chris@hallidayarchitects.com Tel: 609.957.6789 Address: P.O. Box 186 Ocean City, NJ 08226

All of the drawings and documents within these sheets are under the ownership of Halliday Architects and are for the sole use of the construction of the pertaining project. They are not to be traced, copied, scanned, reprinted, reproduced, or otherwise used without the expressed and written consent of Halliday Architects.

PROJECT TEAM:

SIGNATURE LI#21A101936000 CHRISTOPHER HALLIDAY

SUBMITTAL INFO./ DATE

PROJECT INFORMATION: 2187

DATE: 11.23.2021 DRAWN BY: CMH

[PROJECT]

817-819 Park Place Ocean City, NJ

| IPROJECT ADDRESS | 817-819 Park Place

Ocean City, NJ 08226

|OWNER CONTACT| 817-19 Park Place, LLC


11 E 9th Street Suite 3 Ocean City NJ, 08226

Lot 47
Block 302
SHEET NUMBER AND NAME:

A1.01

First + Second

Floor Plans
0' 1' 2' 4'

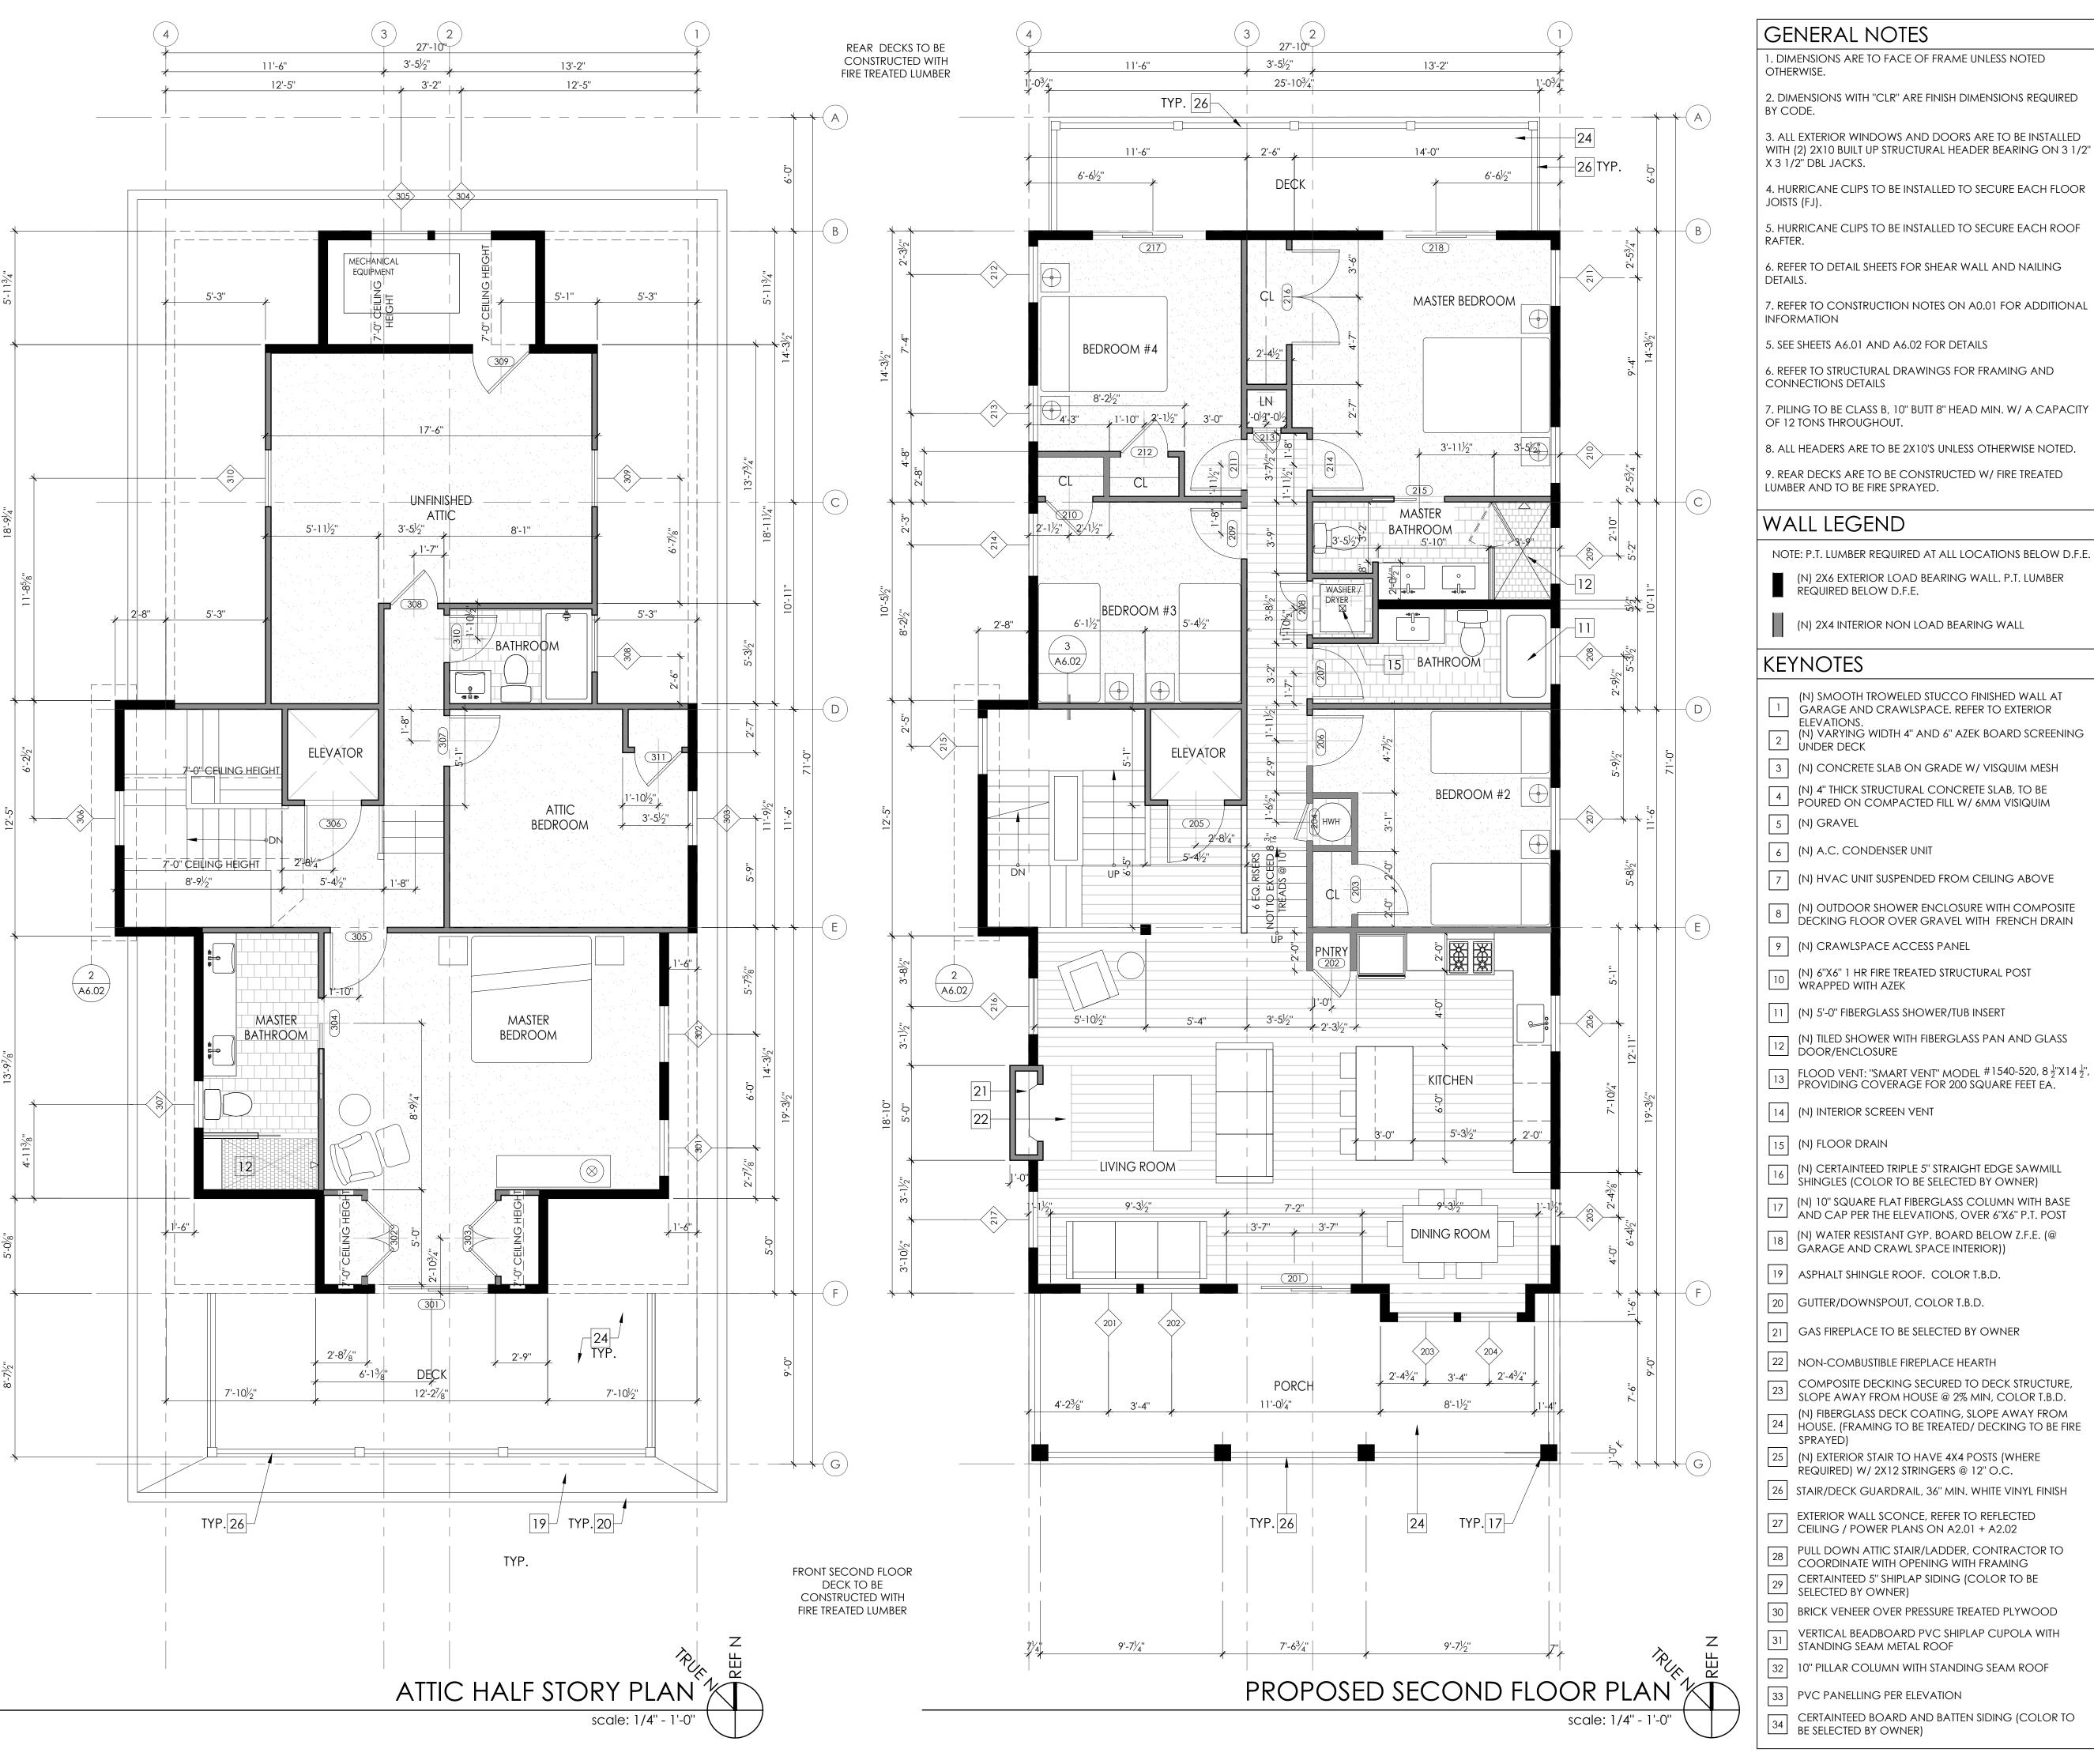

1. DIMENSIONS ARE TO FACE OF FRAME UNLESS NOTED OTHERWISE.

2. DIMENSIONS WITH "CLR" ARE FINISH DIMENSIONS REQUIRED BY CODE.

3. ALL EXTERIOR WINDOWS AND DOORS ARE TO BE INSTALLED WITH (2) 2X10 BUILT UP STRUCTURAL HEADER BEARING ON 3 1/2"

4. HURRICANE CLIPS TO BE INSTALLED TO SECURE EACH FLOOR JOISTS (FJ).

5. HURRICANE CLIPS TO BE INSTALLED TO SECURE EACH ROOF

6. REFER TO DETAIL SHEETS FOR SHEAR WALL AND NAILING

7. REFER TO CONSTRUCTION NOTES ON A0.01 FOR ADDITIONAL INFORMATION

5. SEE SHEETS A6.01 AND A6.02 FOR DETAILS

6. REFER TO STRUCTURAL DRAWINGS FOR FRAMING AND CONNECTIONS DETAILS

OF 12 TONS THROUGHOUT. 8. ALL HEADERS ARE TO BE 2X10'S UNLESS OTHERWISE NOTED.

9. REAR DECKS ARE TO BE CONSTRUCTED W/ FIRE TREATED LUMBER AND TO BE FIRE SPRAYED.

WALL LEGEND

NOTE: P.T. LUMBER REQUIRED AT ALL LOCATIONS BELOW D.F.E.

(N) 2X6 EXTERIOR LOAD BEARING WALL. P.T. LUMBER REQUIRED BELOW D.F.E.

(N) 2X4 INTERIOR NON LOAD BEARING WALL

KEYNOTES

- (N) SMOOTH TROWELED STUCCO FINISHED WALL AT GARAGE AND CRAWLSPACE. REFER TO EXTERIOR
- ELEVATIONS. (N) VARYING WIDTH 4" AND 6" AZEK BOARD SCREENING UNDER DECK
- 3 (N) CONCRETE SLAB ON GRADE W/ VISQUIM MESH
- (N) 4" THICK STRUCTURAL CONCRETE SLAB, TO BE POURED ON COMPACTED FILL W/ 6MM VISIQUIM
- 6 (N) A.C. CONDENSER UNIT
- 7 (N) HVAC UNIT SUSPENDED FROM CEILING ABOVE
- (N) OUTDOOR SHOWER ENCLOSURE WITH COMPOSITE DECKING FLOOR OVER GRAVEL WITH FRENCH DRAIN
- 9 (N) CRAWLSPACE ACCESS PANEL
- (N) 6"X6" 1 HR FIRE TREATED STRUCTURAL POST WRAPPED WITH AZEK
- 11 (N) 5'-0" FIBERGLASS SHOWER/TUB INSERT
- (N) TILED SHOWER WITH FIBERGLASS PAN AND GLASS DOOR/ENCLOSURE
- FLOOD VENT: "SMART VENT" MODEL #1540-520, 8 $\frac{1}{2}$ "X14 $\frac{1}{2}$ ", PROVIDING COVERAGE FOR 200 SQUARE FEET EA.
- 14 (N) INTERIOR SCREEN VENT
- 15 (N) FLOOR DRAIN
- (N) CERTAINTEED TRIPLE 5" STRAIGHT EDGE SAWMILL SHINGLES (COLOR TO BE SELECTED BY OWNER)
- (N) 10" SQUARE FLAT FIBERGLASS COLUMN WITH BASE
- (N) WATER RESISTANT GYP. BOARD BELOW Z.F.E. (@ GARAGE AND CRAWL SPACE INTERIOR))
- 19 ASPHALT SHINGLE ROOF. COLOR T.B.D.
- 20 GUTTER/DOWNSPOUT, COLOR T.B.D.
- 21 GAS FIREPLACE TO BE SELECTED BY OWNER
- COMPOSITE DECKING SECURED TO DECK STRUCTURE, SLOPE AWAY FROM HOUSE @ 2% MIN, COLOR T.B.D.
- (N) FIBERGLASS DECK COATING, SLOPE AWAY FROM HOUSE. (FRAMING TO BE TREATED/ DECKING TO BE FIRE SPRAYED)
- 25 (N) EXTERIOR STAIR TO HAVE 4X4 POSTS (WHERE REQUIRED) W/ 2X12 STRINGERS @ 12" O.C.
- 26 STAIR/DECK GUARDRAIL, 36" MIN. WHITE VINYL FINISH
- EXTERIOR WALL SCONCE, REFER TO REFLECTED CEILING / POWER PLANS ON A2.01 + A2.02
- PULL DOWN ATTIC STAIR/LADDER, CONTRACTOR TO COORDINATE WITH OPENING WITH FRAMING
- CERTAINTEED 5" SHIPLAP SIDING (COLOR TO BE SELECTED BY OWNER)
- 30 BRICK VENEER OVER PRESSURE TREATED PLYWOOD
- VERTICAL BEADBOARD PVC SHIPLAP CUPOLA WITH STANDING SEAM METAL ROOF
- 32 10" PILLAR COLUMN WITH STANDING SEAM ROOF
- 33 PVC PANELLING PER ELEVATION
- CERTAINTEED BOARD AND BATTEN SIDING (COLOR TO BE SELECTED BY OWNER)



Architect: Christopher Halliday email: chris@hallidayarchitects.com Tel: 609.957.6789

All of the drawings and documents within these sheets are under the ownership of Halliday Architects and are for the sole use of the construction of the pertaining project. They are not to be traced, copied, scanned, reprinted, reproduced, or otherwise used without the expressed and written consent of Halliday Architects.

Address: P.O. Box 186 Ocean City, NJ 08226

PROJECT TEAM:

LI#21AI01936000 CHRISTOPHER HALLIDAY

SUBMITTAL INFO./ DATE

PROJECT INFORMATION: 2187 DATE: 11.23.2021 DRAWN BY: CMH

[PROJECT [817-819 Park Place

Ocean City, NJ | PROJECT ADDRESS |

> 817-819 Park Place Ocean City, NJ 08226

OWNER CONTACT 817-19 Park Place, LLC 11 E 9th Street Suite 3


Ocean City NJ, 08226


|LOT AND BLOCK|

Lot 47 Block 302 SHEET NUMBER AND NAME:

A1.02

Second Floor Plan Roof Plan

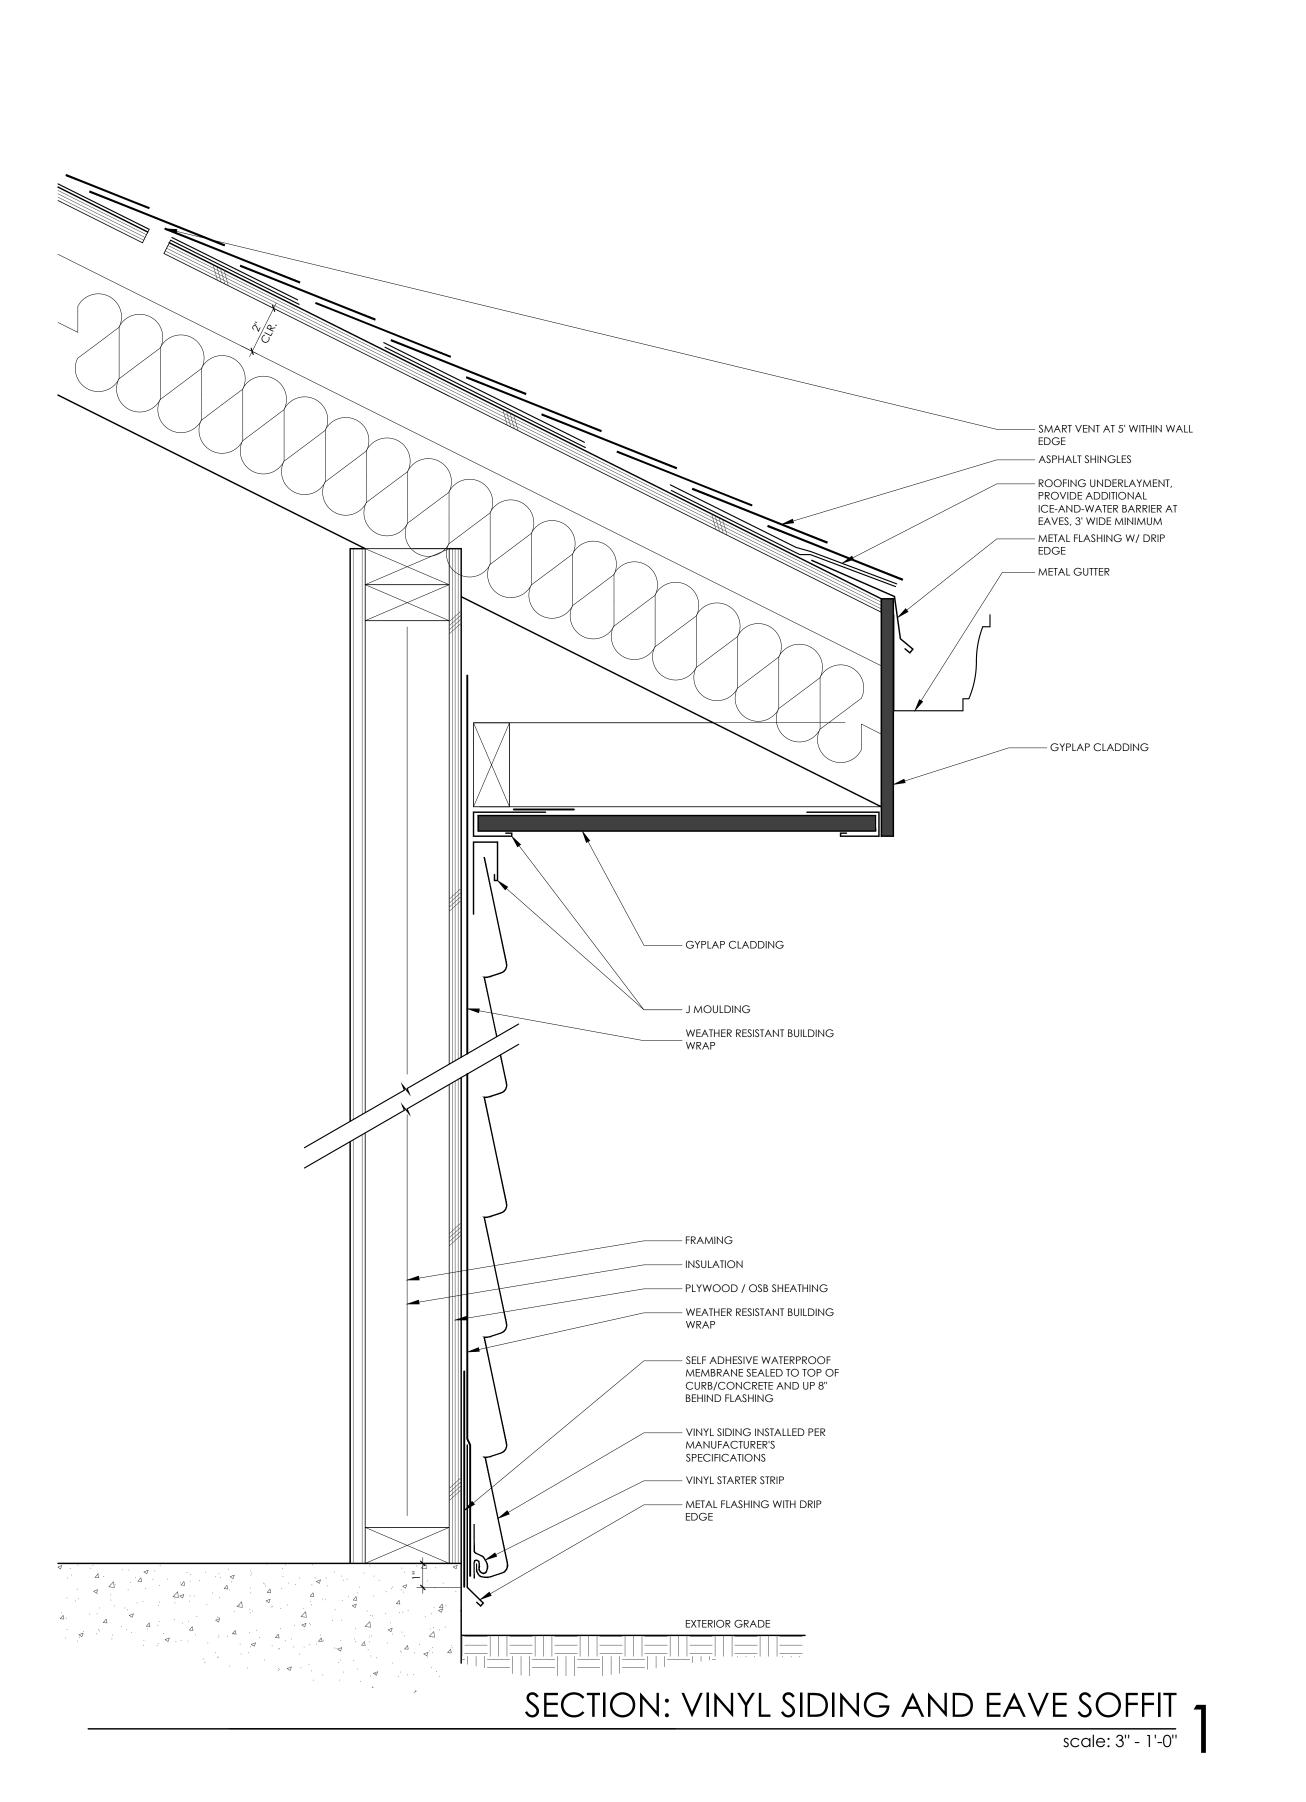

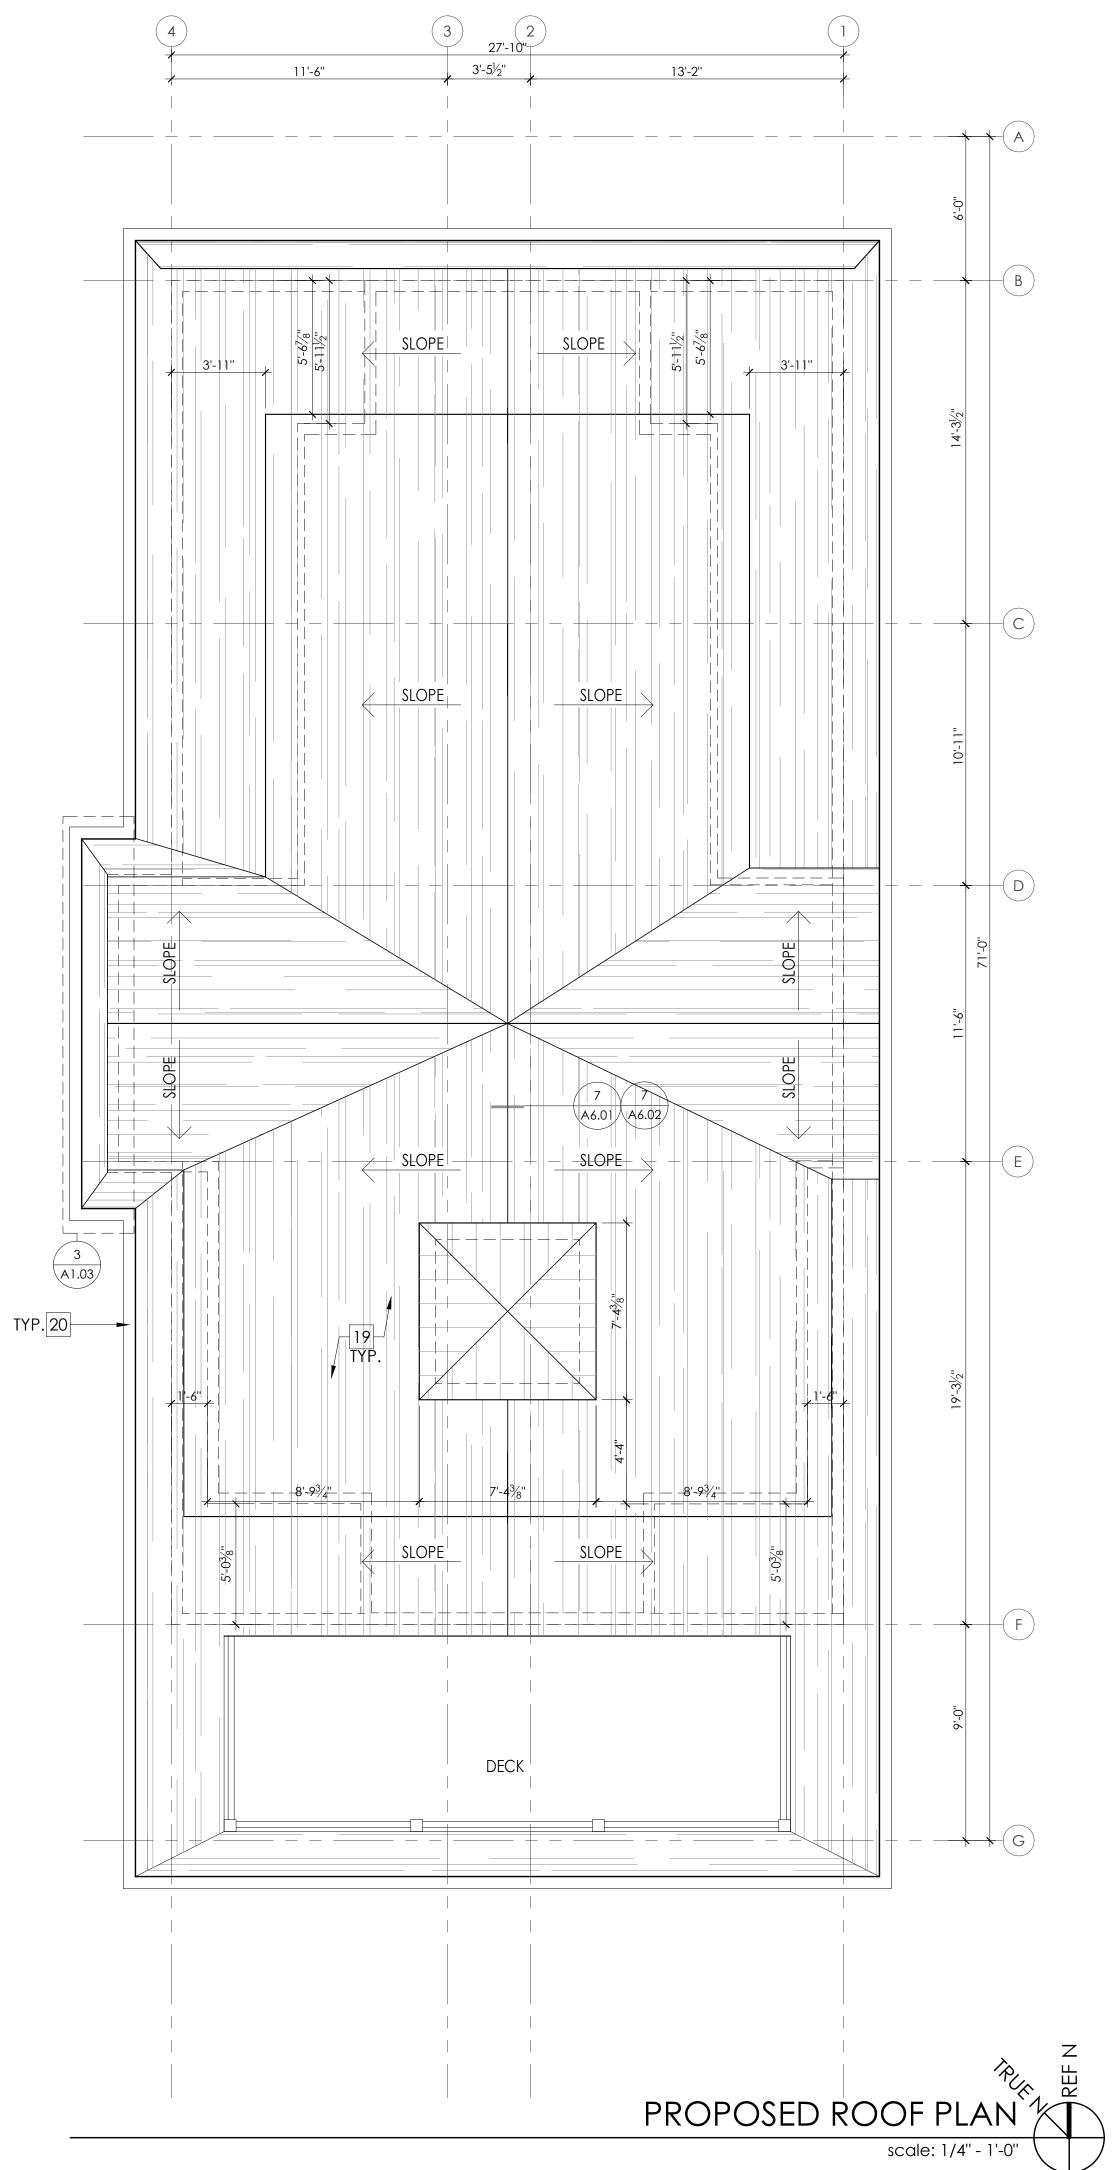

X 3 1/2" DBL JACKS.

DETAILS.

1. DIMENSIONS ARE TO FACE OF FRAME UNLESS NOTED OTHERWISE.

2. DIMENSIONS WITH "CLR" ARE FINISH DIMENSIONS REQUIRED BY CODE.

3. ALL EXTERIOR WINDOWS AND DOORS ARE TO BE INSTALLED WITH (2) 2X10 BUILT UP STRUCTURAL HEADER BEARING ON 3 1/2"

4. HURRICANE CLIPS TO BE INSTALLED TO SECURE EACH FLOOR JOISTS (FJ).

5. HURRICANE CLIPS TO BE INSTALLED TO SECURE EACH ROOF

6. REFER TO DETAIL SHEETS FOR SHEAR WALL AND NAILING

7. REFER TO CONSTRUCTION NOTES ON A0.01 FOR ADDITIONAL INFORMATION

5. SEE SHEETS A6.01 AND A6.02 FOR DETAILS

6. REFER TO STRUCTURAL DRAWINGS FOR FRAMING AND CONNECTIONS DETAILS

OF 12 TONS THROUGHOUT. 8. ALL HEADERS ARE TO BE 2X10'S UNLESS OTHERWISE NOTED.

7. PILING TO BE CLASS B, 10" BUTT 8" HEAD MIN. W/ A CAPACITY

9. REAR DECKS ARE TO BE CONSTRUCTED W/ FIRE TREATED LUMBER AND TO BE FIRE SPRAYED.

WALL LEGEND

NOTE: P.T. LUMBER REQUIRED AT ALL LOCATIONS BELOW D.F.E.

(N) 2X6 EXTERIOR LOAD BEARING WALL. P.T. LUMBER REQUIRED BELOW D.F.E.

(N) 2X4 INTERIOR NON LOAD BEARING WALL

KEYNOTES

- (N) SMOOTH TROWELED STUCCO FINISHED WALL AT GARAGE AND CRAWLSPACE. REFER TO EXTERIOR ELEVATIONS.
- (N) VARYING WIDTH 4" AND 6" AZEK BOARD SCREENING 2 UNDER DECK
- 3 (N) CONCRETE SLAB ON GRADE W/ VISQUIM MESH
- (N) 4" THICK STRUCTURAL CONCRETE SLAB, TO BE POURED ON COMPACTED FILL W/ 6MM VISIQUIM
- 5 (N) GRAVEL
- 6 (N) A.C. CONDENSER UNIT
- 7 (N) HVAC UNIT SUSPENDED FROM CEILING ABOVE
- (N) OUTDOOR SHOWER ENCLOSURE WITH COMPOSITE DECKING FLOOR OVER GRAVEL WITH FRENCH DRAIN
- 9 (N) CRAWLSPACE ACCESS PANEL
- (N) 6"X6" 1 HR FIRE TREATED STRUCTURAL POST WRAPPED WITH AZEK
- 11 (N) 5'-0" FIBERGLASS SHOWER/TUB INSERT
- (N) TILED SHOWER WITH FIBERGLASS PAN AND GLASS DOOR/ENCLOSURE
- FLOOD VENT: "SMART VENT" MODEL #1540-520, 8 ½"X14 ½", PROVIDING COVERAGE FOR 200 SQUARE FEET EA.
- 14 (N) INTERIOR SCREEN VENT
- 15 (N) FLOOR DRAIN
- (N) CERTAINTEED TRIPLE 5" STRAIGHT EDGE SAWMILL SHINGLES (COLOR TO BE SELECTED BY OWNER)
- (N) 10" SQUARE FLAT FIBERGLASS COLUMN WITH BASE
- $\stackrel{1}{\longrightarrow}$ AND CAP PER THE ELEVATIONS, OVER 6"X6" P.T. POST
- (N) WATER RESISTANT GYP. BOARD BELOW Z.F.E. (@ GARAGE AND CRAWL SPACE INTERIOR))
- 19 ASPHALT SHINGLE ROOF. COLOR T.B.D.
- 20 GUTTER/DOWNSPOUT, COLOR T.B.D.
- 21 GAS FIREPLACE TO BE SELECTED BY OWNER
- 22 NON-COMBUSTIBLE FIREPLACE HEARTH
- COMPOSITE DECKING SECURED TO DECK STRUCTURE, SLOPE AWAY FROM HOUSE @ 2% MIN, COLOR T.B.D.
- (N) FIBERGLASS DECK COATING, SLOPE AWAY FROM HOUSE. (FRAMING TO BE TREATED/ DECKING TO BE FIRE SPRAYED)
- 25 (N) EXTERIOR STAIR TO HAVE 4X4 POSTS (WHERE REQUIRED) W/ 2X12 STRINGERS @ 12" O.C.
- 26 STAIR/DECK GUARDRAIL, 36" MIN. WHITE VINYL FINISH
- EXTERIOR WALL SCONCE, REFER TO REFLECTED CEILING / POWER PLANS ON A2.01 + A2.02
- PULL DOWN ATTIC STAIR/LADDER, CONTRACTOR TO COORDINATE WITH OPENING WITH FRAMING
- CERTAINTEED 5" SHIPLAP SIDING (COLOR TO BE SELECTED BY OWNER) 30 BRICK VENEER OVER PRESSURE TREATED PLYWOOD
- VERTICAL BEADBOARD PVC SHIPLAP CUPOLA WITH STANDING SEAM METAL ROOF
- 32 10" PILLAR COLUMN WITH STANDING SEAM ROOF



Halliday Architects Architect: Christopher Halliday

email: chris@hallidayarchitects.com

Tel: 609.957.6789

Address: P.O. Box 186

Ocean City, NJ 08226

All of the drawings and documents within these sheets are under the ownership of Halliday Architects and are for the sole use of the construction of the pertaining project. They are not to be traced, copied, scanned, reprinted, reproduced, or otherwise used without the expressed and written consent of Halliday Architects.

PROJECT TEAM:

LI#21AI01936000 CHRISTOPHER HALLIDAY

SUBMITTAL INFO./ DATE

PROJECT INFORMATION: 2187 DATE: 11.23.2021 DRAWN BY: CMH | PROJECT |

817-819 Park Place Ocean City, NJ

| PROJECT ADDRESS | 817-819 Park Place

Ocean City, NJ 08226

817-19 Park Place, LLC 11 E 9th Street Suite 3 Ocean City NJ, 08226

OWNER CONTACT


|LOT AND BLOCK| Lot 47 Block 302


SHEET NUMBER AND NAME:

Roof Plan

A1.03

33 PVC PANELLING PER ELEVATION CERTAINTEED BOARD AND BATTEN SIDING (COLOR TO BE SELECTED BY OWNER)

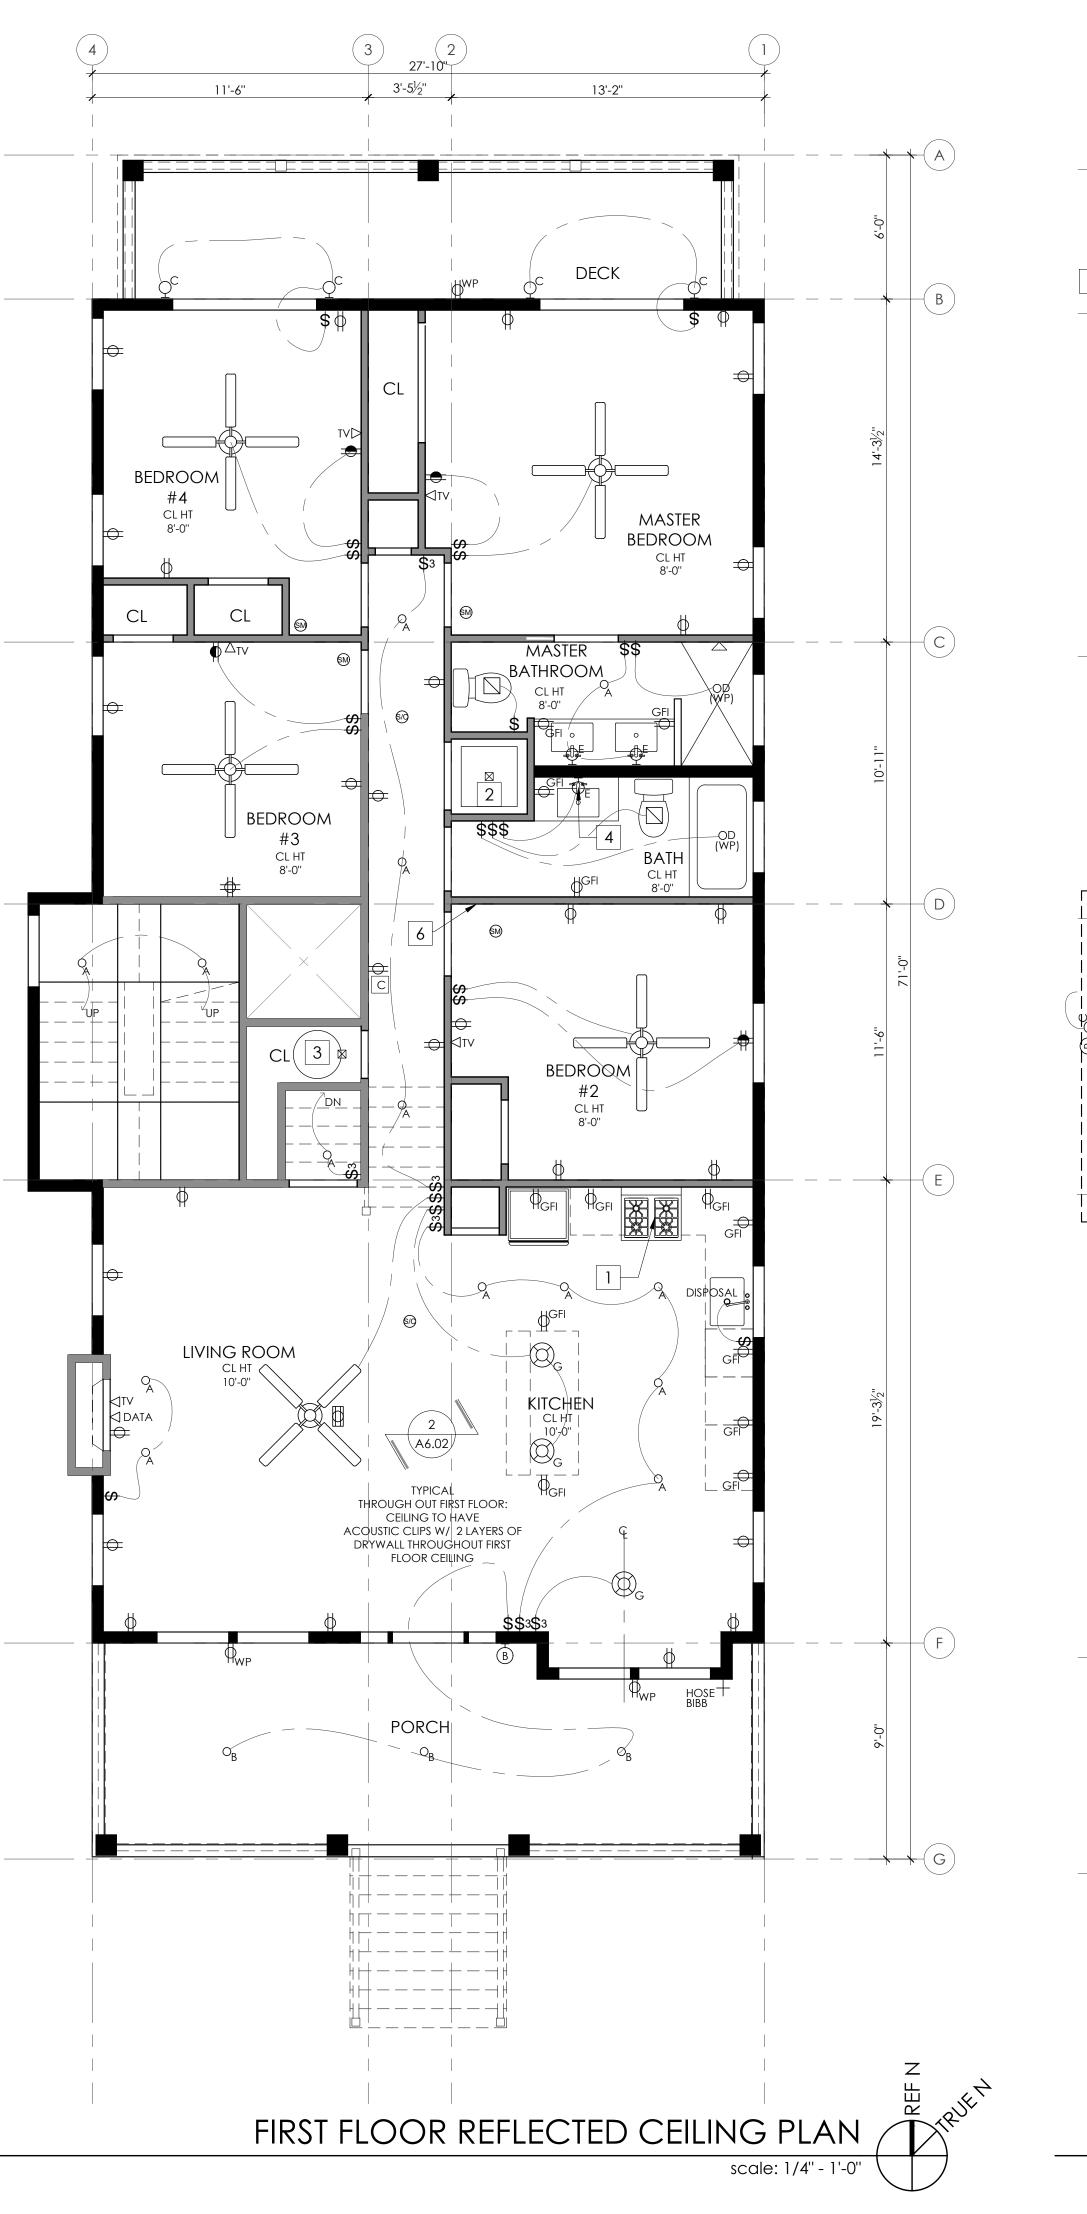

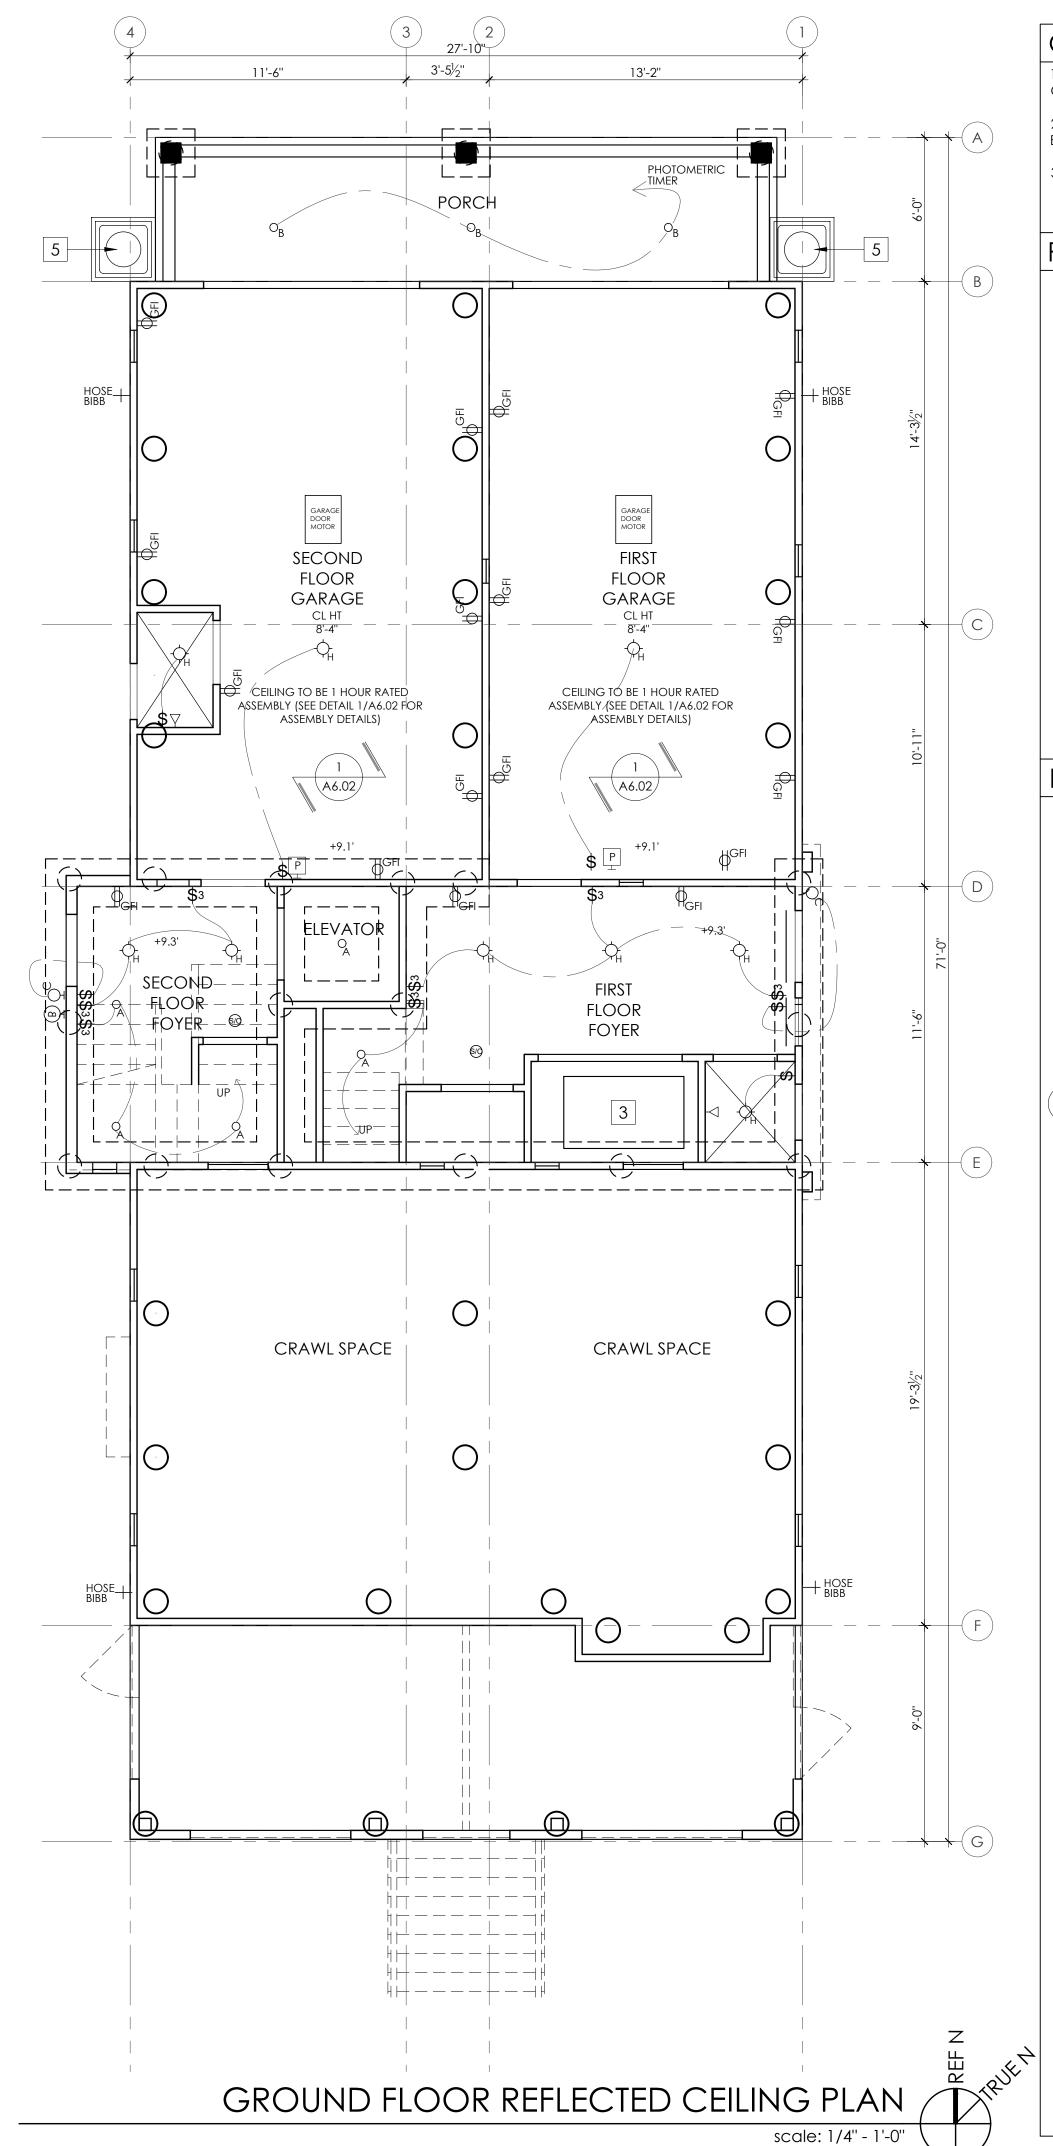

GENERAL ELECTRICAL NOTES

1. DIMENSIONS ARE TO FACE OF FRAMING UNLESS NOTED

2. DIMENSIONS WITH "CLR" ARE FINISH DIMENSIONS REQUIRED

3. AUDIO VISUAL EQUIPMENT TO BE CONTRACTED SEPARATELY

RCP KEYNOTES

- (N) KITCHEN HOOD AND RANGE (PROVIDE GAS AND OR ELECTRICAL AS REQUIRED)
- 2 (N) ELECTRICAL/GAS SERVICE FOR WASHER/ DRYER TO BE CONNECTED TO INDIVIDUAL, PROPERLY GROUNDED BRANCH CIRCUIT WITH 120/240V OR 120/208V SINGLE PHASE 60 HZ ELECTRICAL SERVICE AND SHOULD BE PROTECTED BY 30 AMP TIME DELAY FUSES OR CIRCUIT

BREAKERS KW RATING PER VOLTAGE (240/208.)

- (N) ELECTRICAL AND GAS SERVICE FOR MECHANICAL EQUIPMENT (AS REQUIRED)
- (N) WALL SCONCE LOCATED ABOVE THE VANITY AND MIRROR CENTERED ON THE VANITY (FIXTURE TO BE SELECTED BY OWNER). OWNER TO CONFIRM MOUNTING
- (N) HVAC CONDENSER (INSTALLED PER MANUFACTURERS REQUIREMENTS)
- 6 FLUSH MOUNTED ELECTRICAL PANEL



Halliday Architects

Architect: Christopher Halliday email: chris@hallidayarchitects.com Tel: 609.957.6789 Address: P.O. Box 186 Ocean City, NJ 08226

All of the drawings and documents within these sheets are under the ownership of Halliday Architects and are for the sole use of the construction of the pertaining project. They are not to be traced, copied, scanned, reprinted, reproduced, or otherwise used without the expressed and written consent of Halliday Architects.

PROJECT TEAM:

ELECTRICAL SYMBOL LEGEND

- (N) "PROGRESS" 4" ZERO SIGHT LINE RECESSED DOWN LIGHT DIMMABLE WHERE NOTED
- (N) "PROGRESS" EXTERIOR 4" ZERO SIGHT LINE RECESSED DOWN LIGHT
- (N) EXTERIOR WALL MOUNTED SCONCE (TO BE SELECTED BY OWNER)
- OD (N)WATERPROOF FIXTURE
- (N) INTERIOR WALL MOUNTED SCONCE E (TO BE SELECTED BY OWNER)
- (N) UNDERCOUNTER LED TAPE LIGHT
- (N) CEILING HUNG PENDENT/ CHANDELIER TO BE SELECTED BY OWNER
- (N) SURFACE MOUNTED CLNG. FIXTURE (TO BE SELECTED)
- J NOT USED
- K NOT USED
- (N) EXHAUST FAN BY PANASONIC: GREEN WHISPER FAN (NO LIGHT)



(N) CEILING FAN W/ INTEGRAL LIGHT (SPECIFICAITON TO BE SELECTED BY OWNER)

DATA > (N) CAT5 DATA CABLE HOOKUP

- TV \triangleright (N) TELEVISION CABLE HOOKUP
- (N) TELEPHONE OUTLET
- (N) 120 V DUPLEX FLOOR OUTLET
- (N) 120 V DUPLEX OUTLET
- (N) 120 V GROUND FAULT INTERRUPTER
- AFCI (N) 120 V ARC FAULT CIRCUT INTERRUPTER
- (N) 120 V DUPLEX OUTLET TOP HALF SWITCH (N) 120 V WEATHERPROOF DUPLEX OUTLET
- SINGLE POLE SWITCH
- \$3 THREE-WAY SWITCH \$D SINGLE POLE DIMMER
- \$ M MANUAL ON MOTION SENSOR SWITCH
- M MOTION SENSOR WET RATED
- THERMOSTAT
- DOORBELL CHIMES
- DOORBELL BUTTON
- PUSH BUTTON GARAGE DOOR OPERATION SWITCH (N) CEILING MOUNTED SMOKE AND CARBON
- MONOXIDE DETECTORS WITH BATTERY BACKUP (N) CEILING MOUNTED SMOKE DETECTORS WITH BATTERY BACKUP

SIGNATURE CHRISTOPHER HALLIDAY

SUBMITTAL INFO./ DATE

PROJECT INFORMATION: 2187 DATE: 11.23.2021 DRAWN BY: CMH

817-819 Park Place Ocean City, NJ

| PROJECT ADDRESS |

Ocean City, NJ 08226 OWNER CONTACT

817-819 Park Place

Block 302

817-19 Park Place, LLC 11 E 9th Street Suite 3 Ocean City NJ, 08226


| LOT AND BLOCK | Lot 47

A2.01

SHEET NUMBER AND NAME:

Ground + First Floor Plans

Reflected Ceiling

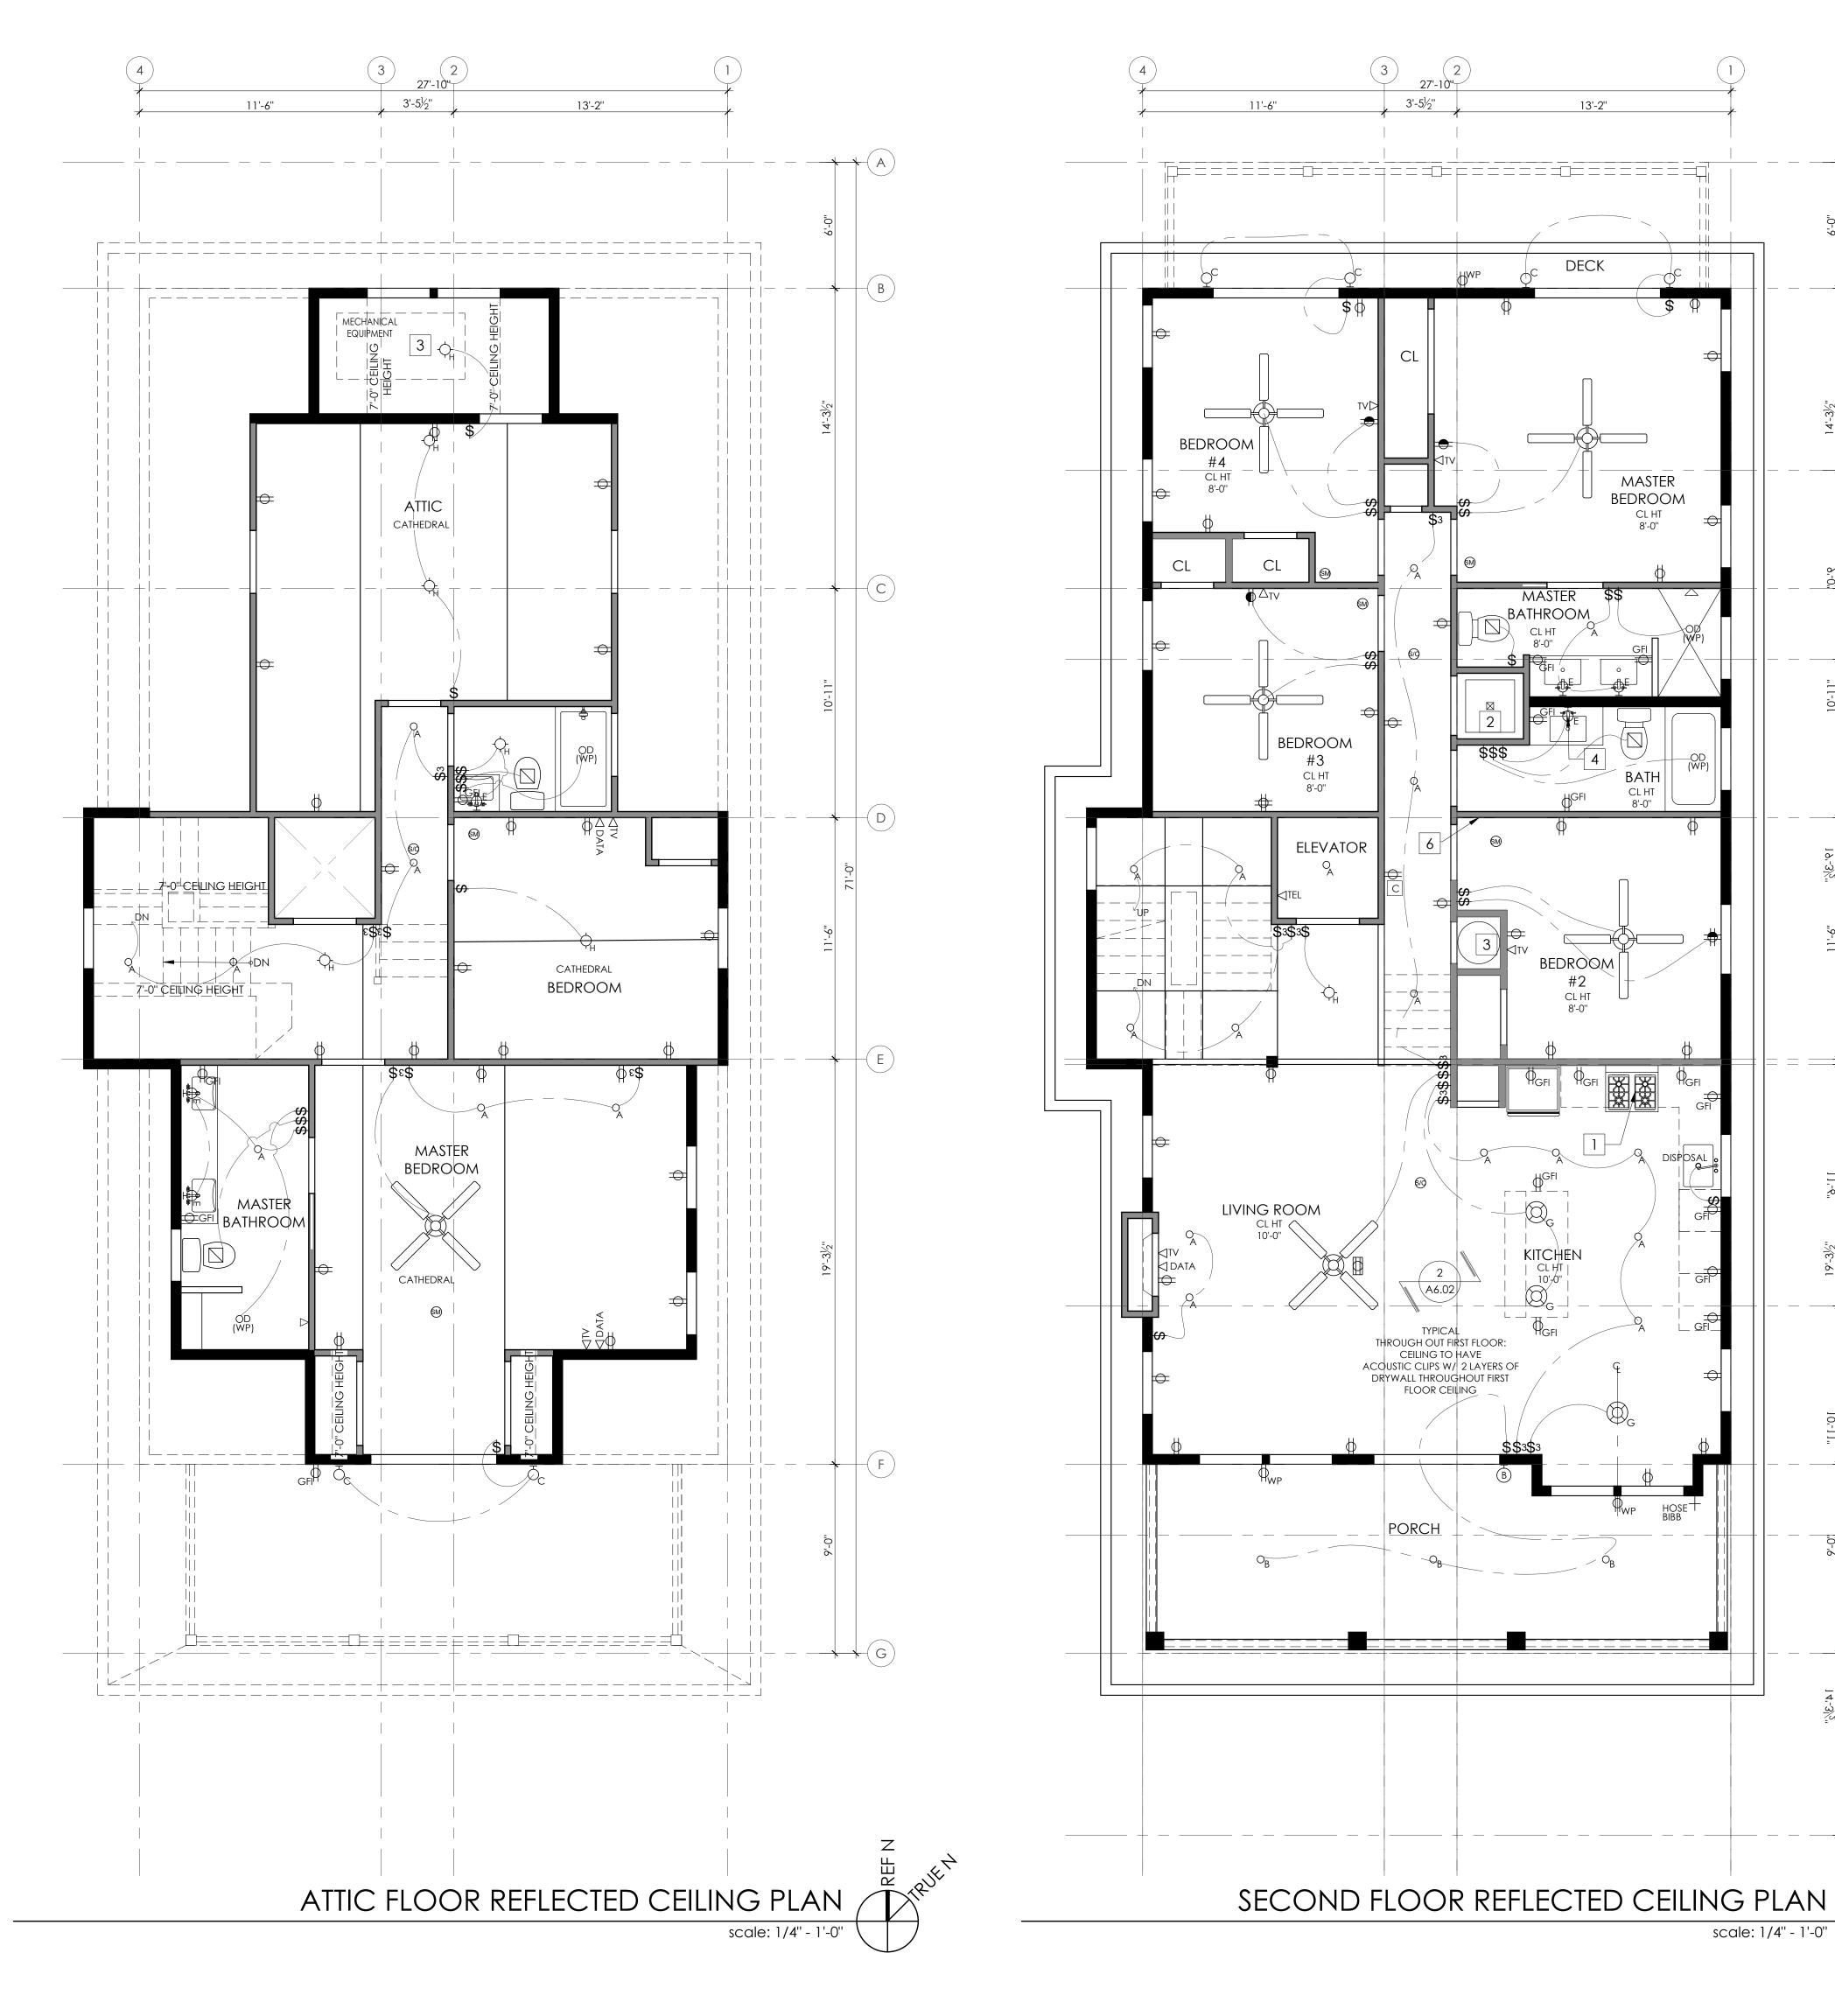

GENERAL ELECTRICAL NOTES

1. DIMENSIONS ARE TO FACE OF FRAMING UNLESS NOTED

2. DIMENSIONS WITH "CLR" ARE FINISH DIMENSIONS REQUIRED

3. AUDIO VISUAL EQUIPMENT TO BE CONTRACTED SEPARATELY

RCP KEYNOTES

- (N) KITCHEN HOOD AND RANGE (PROVIDE GAS AND OR ELECTRICAL AS REQUIRED)
- 2 (N) ELECTRICAL/GAS SERVICE FOR WASHER/ DRYER TO BE CONNECTED TO INDIVIDUAL, PROPERLY GROUNDED BRANCH CIRCUIT WITH 120/240V OR 120/208V SINGLE PHASE 60 HZ ELECTRICAL SERVICE AND SHOULD BE PROTECTED BY 30 AMP TIME DELAY FUSES OR CIRCUIT BREAKERS KW RATING PER VOLTAGE (240/208.)
- (N) ELECTRICAL AND GAS SERVICE FOR MECHANICAL EQUIPMENT (AS REQUIRED)
- (N) WALL SCONCE LOCATED ABOVE THE VANITY AND MIRROR CENTERED ON THE VANITY (FIXTURE TO BE SELECTED BY OWNER). OWNER TO CONFIRM MOUNTING
- (N) HVAC CONDENSER (INSTALLED PER MANUFACTURERS REQUIREMENTS)
- 6 | FLUSH MOUNTED ELECTRICAL PANEL



Halliday Architects

Architect: Christopher Halliday email: chris@hallidayarchitects.com Tel: 609.957.6789 Address: P.O. Box 186 Ocean City, NJ 08226

All of the drawings and documents within these sheets are under the ownership of Halliday Architects and are for the sole use of the construction of the pertaining project. They are not to be traced, copied, scanned, reprinted, reproduced, or otherwise used without the expressed and written consent of Halliday Architects.

PROJECT TEAM:

ELECTRICAL SYMBOL LEGEND

- (N) "PROGRESS" 4" ZERO SIGHT LINE RECESSED DOWN LIGHT DIMMABLE WHERE NOTED
- (N) "PROGRESS" EXTERIOR 4" ZERO SIGHT LINE RECESSED DOWN LIGHT
- (N) EXTERIOR WALL MOUNTED SCONCE (TO BE SELECTED BY OWNER)
- \bigcirc_{D} (N)WATERPROOF FIXTURE
- (N) INTERIOR WALL MOUNTED SCONCE E (TO BE SELECTED BY OWNER)
- (N) UNDERCOUNTER LED TAPE LIGHT
- (N) CEILING HUNG PENDENT/ CHANDELIER TO BE SELECTED BY OWNER
- (N) SURFACE MOUNTED CLNG. FIXTURE (TO BE SELECTED)
- J NOT USED
- K NOT USED
- (N) EXHAUST FAN BY PANASONIC: GREEN WHISPER FAN (NO LIGHT)



(N) CEILING FAN W/ INTEGRAL LIGHT (SPECIFICAITON TO BE SELECTED BY OWNER)

DATA > (N) CAT5 DATA CABLE HOOKUP

- TV \triangleright (N) TELEVISION CABLE HOOKUP
- (N) TELEPHONE OUTLET
- (N) 120 V DUPLEX FLOOR OUTLET
- (N) 120 V DUPLEX OUTLET
- (N) 120 V GROUND FAULT INTERRUPTER
- AFCI (N) 120 V ARC FAULT CIRCUT INTERRUPTER
- (N) 120 V DUPLEX OUTLET TOP HALF SWITCH (N) 120 V WEATHERPROOF DUPLEX OUTLET
- SINGLE POLE SWITCH
- \$3 THREE-WAY SWITCH
- \$D SINGLE POLE DIMMER
- \$ M MANUAL ON MOTION SENSOR SWITCH
- M MOTION SENSOR WET RATED
- THERMOSTAT
- DOORBELL CHIMES
- DOORBELL BUTTON
- PUSH BUTTON GARAGE DOOR OPERATION SWITCH (N) CEILING MOUNTED SMOKE AND CARBON
- MONOXIDE DETECTORS WITH BATTERY BACKUP
- (N) CEILING MOUNTED SMOKE DETECTORS WITH BATTERY BACKUP

SIGNATURE CHRISTOPHER HALLIDAY

SUBMITTAL INFO./ DATE

PROJECT INFORMATION: 2187 DATE: 11.23.2021 DRAWN BY: CMH

817-819 Park Place Ocean City, NJ

| PROJECT ADDRESS | 817-819 Park Place

08226 OWNER CONTACT


Ocean City, NJ


817-19 Park Place, LLC 11 E 9th Street Suite 3 Ocean City NJ, 08226

| LOT AND BLOCK | Lot 47 Block 302 SHEET NUMBER AND NAME:

A2.02

Second Floor + Attic Floor Plan Reflected Ceiling Plan

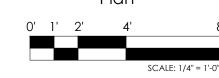

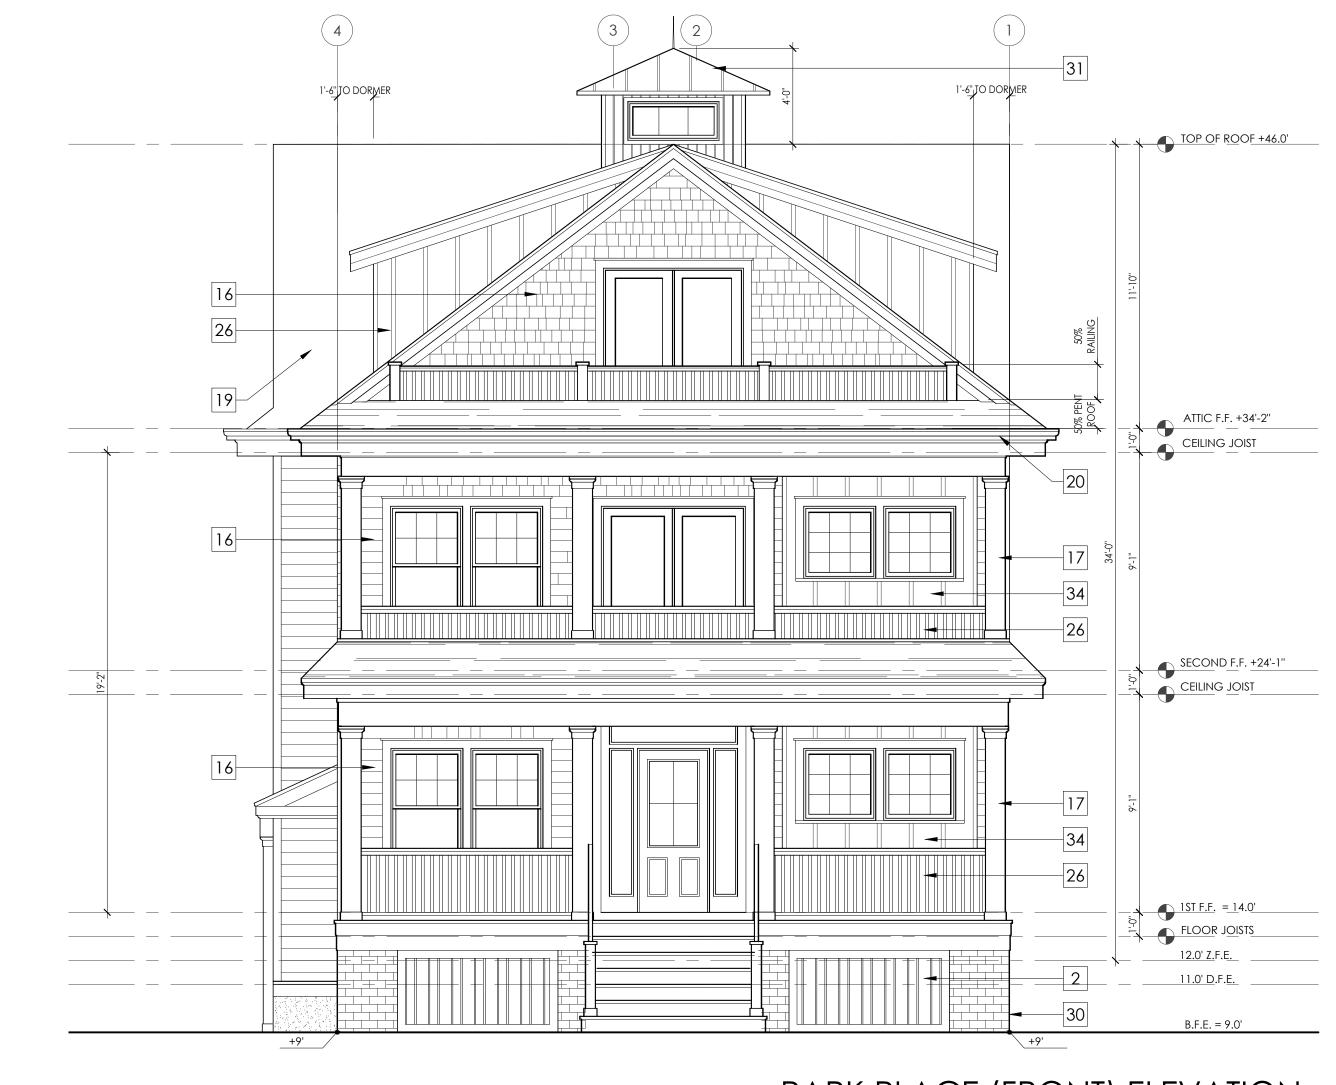



SIDE (WEST) ELEVATION

GENERAL NOTES

1. DIMENSIONS ARE TO FACE OF FRAME UNLESS NOTED OTHERWISE.

2. DIMENSIONS WITH "CLR" ARE FINISH DIMENSIONS REQUIRED BY CODE.

3. ALL EXTERIOR WINDOWS AND DOORS ARE TO BE INSTALLED WITH (2) 2X10 BUILT UP STRUCTURAL HEADER BEARING ON 3 1/2" X 3 1/2" DBL JACKS.

4. HURRICANE CLIPS TO BE INSTALLED TO SECURE EACH FLOOR JOISTS (FJ).

5. HURRICANE CLIPS TO BE INSTALLED TO SECURE EACH ROOF

6. REFER TO DETAIL SHEETS FOR SHEAR WALL AND NAILING

DETAILS.

7. REFER TO CONSTRUCTION NOTES ON A0.01 FOR ADDITIONAL INFORMATION

5. SEE SHEETS A6.01 AND A6.02 FOR DETAILS

6. REFER TO STRUCTURAL DRAWINGS FOR FRAMING AND CONNECTIONS DETAILS

7. PILING TO BE CLASS B, 10" BUTT 8" HEAD MIN. W/ A CAPACITY OF 12 TONS THROUGHOUT.

8. ALL HEADERS ARE TO BE 2X10'S UNLESS OTHERWISE NOTED. 9. REAR DECKS ARE TO BE CONSTRUCTED W/ FIRE TREATED LUMBER AND TO BE FIRE SPRAYED.

WALL LEGEND

NOTE: P.T. LUMBER REQUIRED AT ALL LOCATIONS BELOW D.F.E.

(N) 2X6 EXTERIOR LOAD BEARING WALL. P.T. LUMBER REQUIRED BELOW D.F.E.

(N) 2X4 INTERIOR NON LOAD BEARING WALL

KEYNOTES

- (N) SMOOTH TROWELED STUCCO FINISHED WALL AT GARAGE AND CRAWLSPACE. REFER TO EXTERIOR ELEVATIONS.
- (N) VARYING WIDTH 4" AND 6" AZEK BOARD SCREENING (N) VARYING V UNDER DECK
- | 3 | (N) CONCRETE SLAB ON GRADE W/ VISQUIM MESH
- (N) 4" THICK STRUCTURAL CONCRETE SLAB, TO BE POURED ON COMPACTED FILL W/ 6MM VISIQUIM 5 (N) GRAVEL
- 6 (N) A.C. CONDENSER UNIT
- 7 (N) HVAC UNIT SUSPENDED FROM CEILING ABOVE
- (N) OUTDOOR SHOWER ENCLOSURE WITH COMPOSITE DECKING FLOOR OVER GRAVEL WITH FRENCH DRAIN
- 9 (N) CRAWLSPACE ACCESS PANEL
- (N) 6"X6" 1 HR FIRE TREATED STRUCTURAL POST WRAPPED WITH AZEK
- 11 (N) 5'-0" FIBERGLASS SHOWER/TUB INSERT
- (N) TILED SHOWER WITH FIBERGLASS PAN AND GLASS DOOR/ENCLOSURE
- FLOOD VENT: "SMART VENT" MODEL #1540-520, 8 $\frac{1}{2}$ "X14 $\frac{1}{2}$ ", PROVIDING COVERAGE FOR 200 SQUARE FEET EA.
- 14 (N) INTERIOR SCREEN VENT
- 15 (N) FLOOR DRAIN
- (N) CERTAINTEED TRIPLE 5" STRAIGHT EDGE SAWMILL SHINGLES (COLOR TO BE SELECTED BY OWNER)
- (N) 10" SQUARE FLAT FIBERGLASS COLUMN WITH BASE AND CAP PER THE ELEVATIONS, OVER 6"X6" P.T. POST
- (N) WATER RESISTANT GYP. BOARD BELOW Z.F.E. (@ GARAGE AND CRAWL SPACE INTERIOR))
- 19 ASPHALT SHINGLE ROOF. COLOR T.B.D.
- 20 GUTTER/DOWNSPOUT, COLOR T.B.D.
- 21 GAS FIREPLACE TO BE SELECTED BY OWNER
- 22 NON-COMBUSTIBLE FIREPLACE HEARTH
- COMPOSITE DECKING SECURED TO DECK STRUCTURE, SLOPE AWAY FROM HOUSE @ 2% MIN, COLOR T.B.D.
- (N) FIBERGLASS DECK COATING, SLOPE AWAY FROM HOUSE. (FRAMING TO BE TREATED/ DECKING TO BE FIRE SPRAYED)
- (N) EXTERIOR STAIR TO HAVE 4X4 POSTS (WHERE REQUIRED) W/ 2X12 STRINGERS @ 12" O.C.
- 26 STAIR/DECK GUARDRAIL, 36" MIN. WHITE VINYL FINISH
- EXTERIOR WALL SCONCE, REFER TO REFLECTED CEILING / POWER PLANS ON A2.01 + A2.02
- PULL DOWN ATTIC STAIR/LADDER, CONTRACTOR TO COORDINATE WITH OPENING WITH FRAMING CERTAINTEED 5" SHIPLAP SIDING (COLOR TO BE SELECTED BY OWNER)
- 30 BRICK VENEER OVER PRESSURE TREATED PLYWOOD
- VERTICAL BEADBOARD PVC SHIP STANDING SEAM METAL ROOF VERTICAL BEADBOARD PVC SHIPLAP CUPOLA WITH
- 32 10" PILLAR COLUMN WITH STANDING SEAM ROOF
- 33 PVC PANELLING PER ELEVATION
- CERTAINTEED BOARD AND BATTEN SIDING (COLOR TO BE SELECTED BY OWNER)



Halliday Architects

Architect: Christopher Halliday email: chris@hallidayarchitects.com Tel: 609.957.6789 Address: P.O. Box 186 Ocean City, NJ 08226

All of the drawings and documents within these sheets are under the ownership of Halliday Architects and are for the sole use of the construction of the pertaining project. They are not to be traced, copied, scanned, reprinted, reproduced, or otherwise used without the expressed and written consent of Halliday Architects.

PROJECT TEAM:

LI#21AI01936000 CHRISTOPHER HALLIDAY

SUBMITTAL INFO./ DATE

PROJECT INFORMATION:2187

| PROJECT | 817-819 Park Place

DATE: 11.23.2021

Ocean City, NJ

| PROJECT ADDRESS | 817-819 Park Place Ocean City, NJ 08226

OWNER CONTACT 817-19 Park Place, LLC 11 E 9th Street Suite 3


Ocean City NJ, 08226

|LOT AND BLOCK| Lot 47 Block 302 SHEET NUMBER AND NAME:

A3.01

Elevations



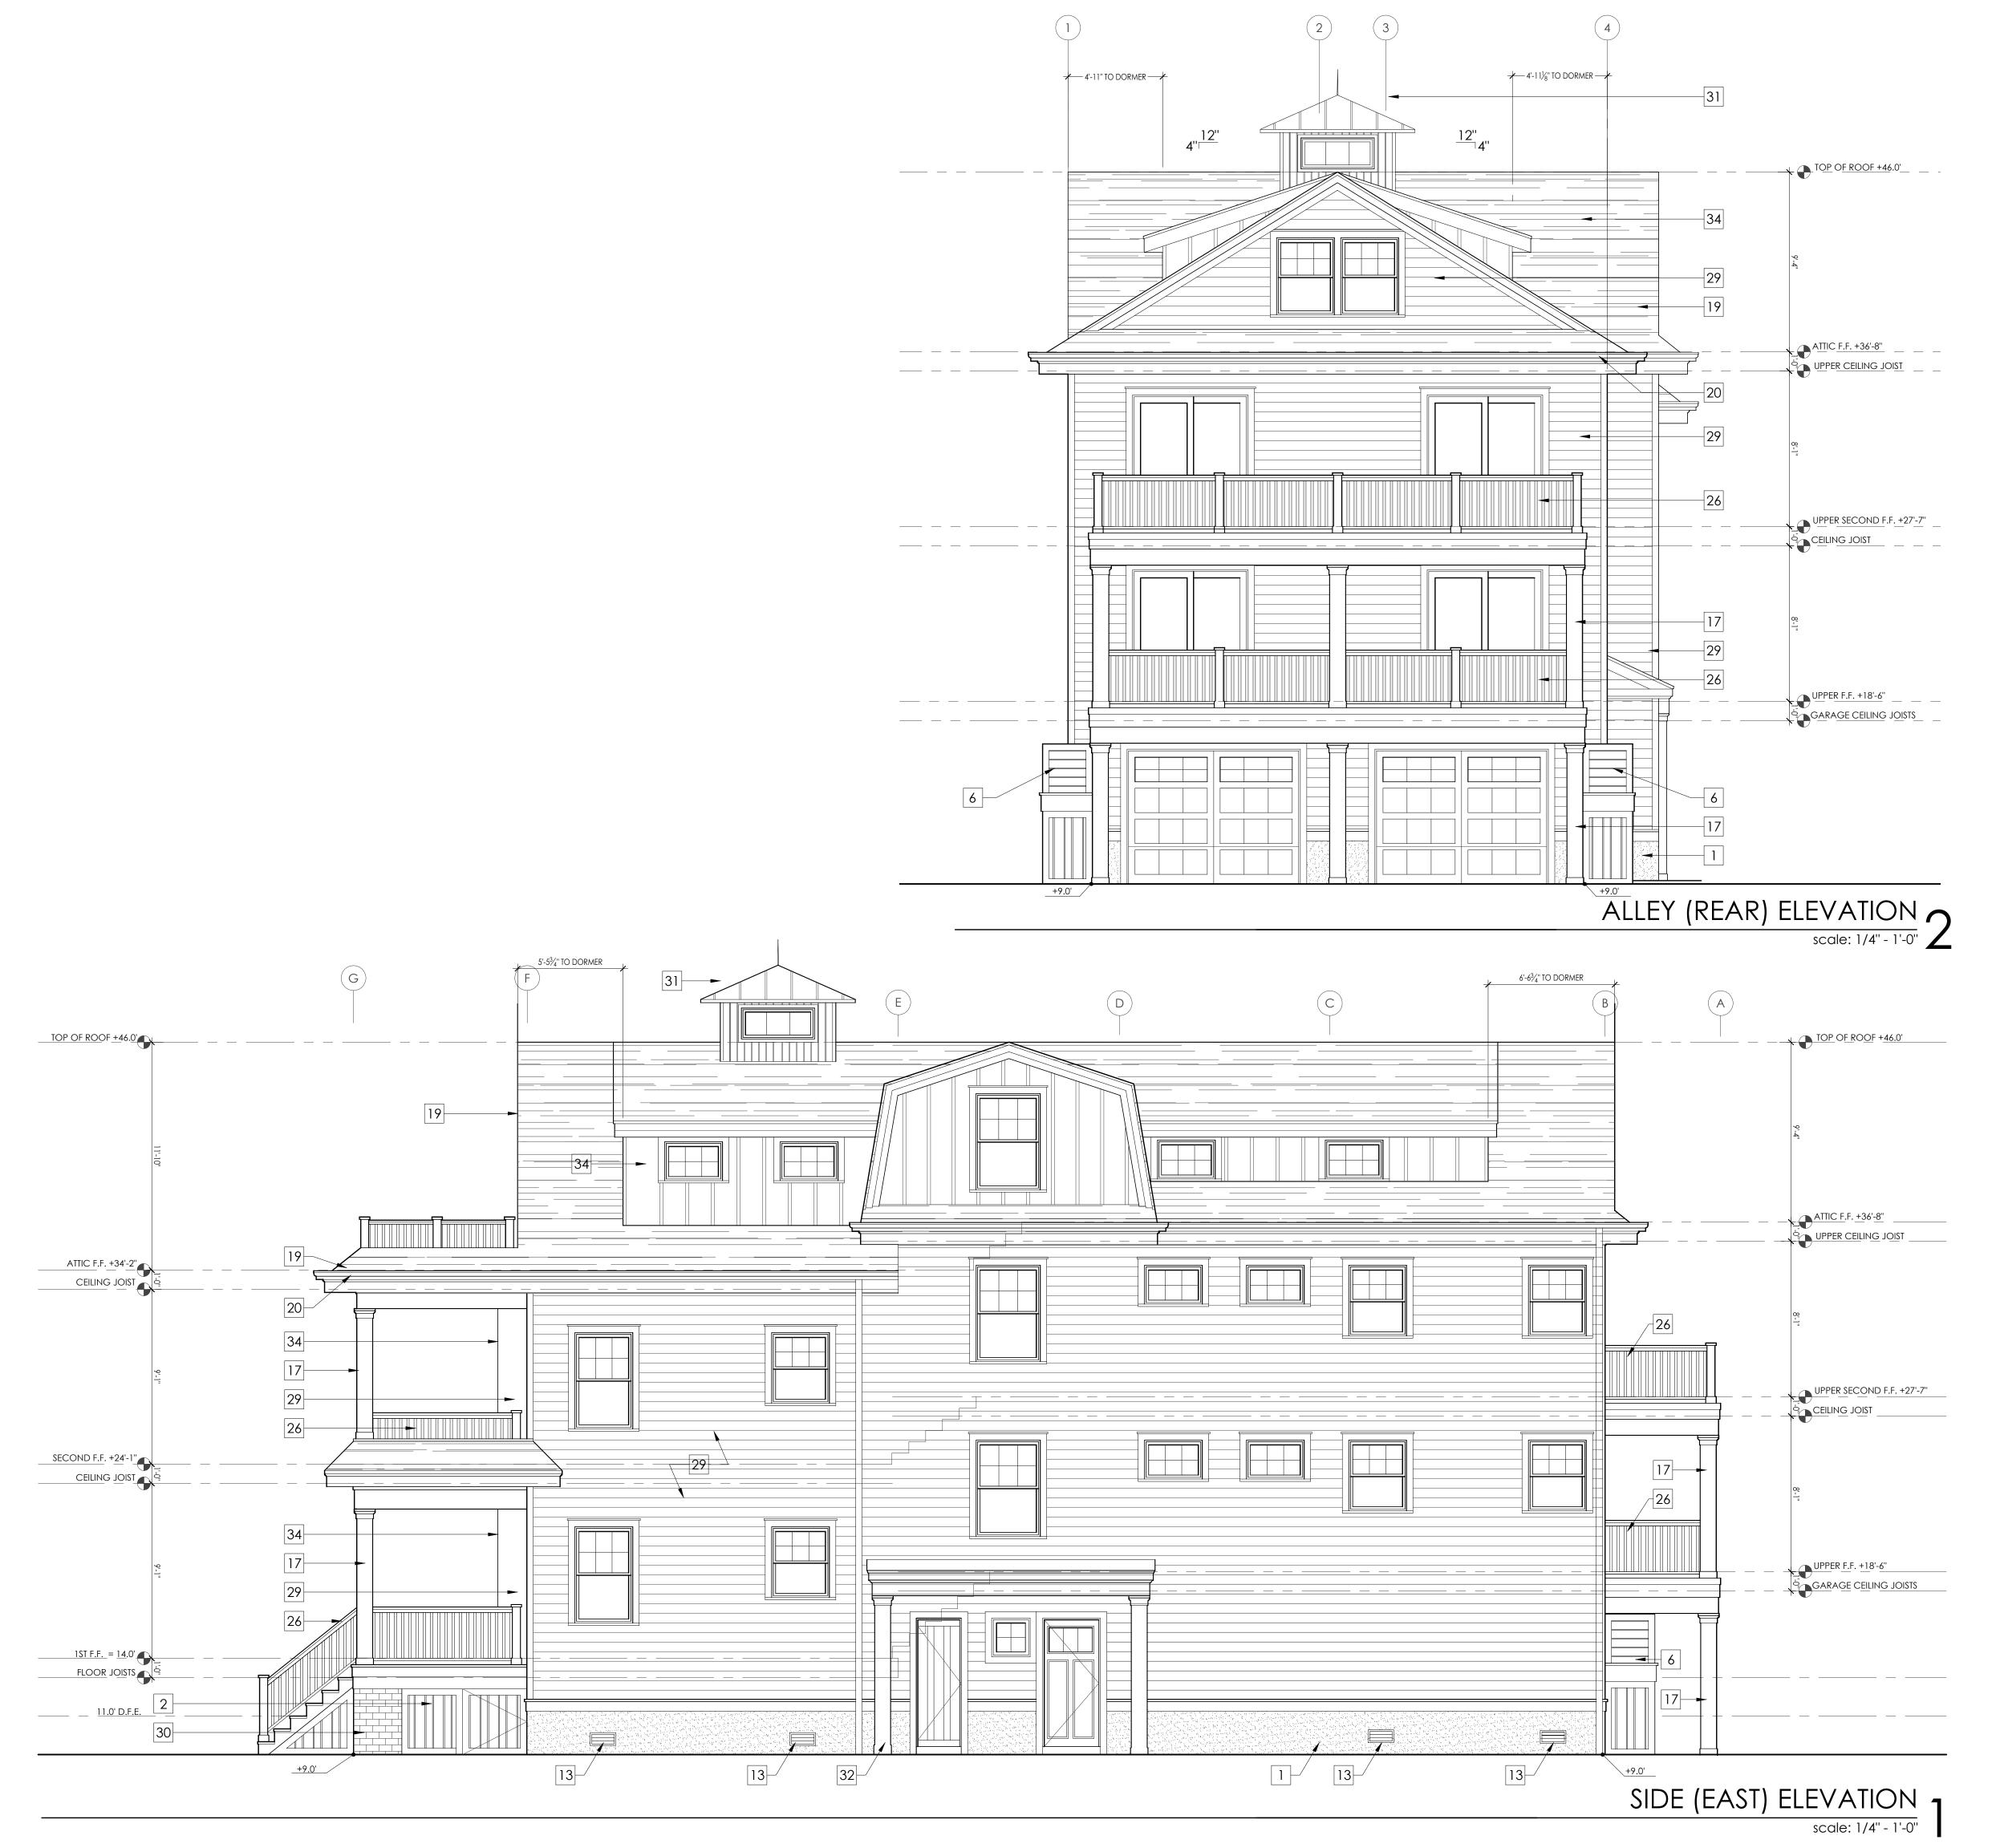

1. DIMENSIONS ARE TO FACE OF FRAME UNLESS NOTED

2. DIMENSIONS WITH "CLR" ARE FINISH DIMENSIONS REQUIRED BY CODE

BY CODE.

3. ALL EXTERIOR WINDOWS AND DOORS ARE TO BE INSTALLED

X 3 1/2" DBL JACKS.

4. HURRICANE CLIPS TO BE INSTALLED TO SECURE EACH FLOOR

WITH (2) 2X10 BUILT UP STRUCTURAL HEADER BEARING ON 3 1/2"

JOISTS (FJ).

5. HURRICANE CLIPS TO BE INSTALLED TO SECURE EACH ROOF RAFTER.

6. REFER TO DETAIL SHEETS FOR SHEAR WALL AND NAILING DETAILS.

7. REFER TO CONSTRUCTION NOTES ON A0.01 FOR ADDITIONAL INFORMATION

5. SEE SHEETS A6.01 AND A6.02 FOR DETAILS

6. REFER TO STRUCTURAL DRAWINGS FOR FRAMING AND CONNECTIONS DETAILS

7. PILING TO BE CLASS B, 10" BUTT 8" HEAD MIN. W/ A CAPACITY OF 12 TONS THROUGHOUT.

8. ALL HEADERS ARE TO BE 2X10'S UNLESS OTHERWISE NOTED.

9. REAR DECKS ARE TO BE CONSTRUCTED W/ FIRE TREATED LUMBER AND TO BE FIRE SPRAYED.

WALL LEGEND

NOTE: P.T. LUMBER REQUIRED AT ALL LOCATIONS BELOW D.F.E.

(N) 2X6 EXTERIOR LOAD BEARING WALL. P.T. LUMBER REQUIRED BELOW D.F.E.

(N) 2X4 INTERIOR NON LOAD BEARING WALL

KEYNOTES

- (N) SMOOTH TROWELED STUCCO FINISHED WALL AT GARAGE AND CRAWLSPACE. REFER TO EXTERIOR
- ELEVATIONS.


 (N) VARYING WIDTH 4" AND 6" AZEK BOARD SCREENING UNDER DECK
- 3 (N) CONCRETE SLAB ON GRADE W/ VISQUIM MESH
- (N) 4" THICK STRUCTURAL CONCRETE SLAB, TO BE POURED ON COMPACTED FILL W/ 6MM VISIQUIM

 [5] (N) GRAVEL
- 6 (N) A.C. CONDENSER UNIT
- 7 (N) HVAC UNIT SUSPENDED FROM CEILING ABOVE
- (N) OUTDOOR SHOWER ENCLOSURE WITH COMPOSITE DECKING FLOOR OVER GRAVEL WITH FRENCH DRAIN
- 9 (N) CRAWLSPACE ACCESS PANEL
- (N) 6"X6" 1 HR FIRE TREATED STRUCTURAL POST WRAPPED WITH AZEK
- 11 (N) 5'-0" FIBERGLASS SHOWER/TUB INSERT
- (N) TILED SHOWER WITH FIBERGLASS PAN AND GLASS DOOR/ENCLOSURE
- FLOOD VENT: "SMART VENT" MODEL #1540-520, $8\frac{1}{2}$ "X14 $\frac{1}{2}$ ", PROVIDING COVERAGE FOR 200 SQUARE FEET EA.
- 14 (N) INTERIOR SCREEN VENT
- 15 (N) FLOOR DRAIN
- (N) CERTAINTEED TRIPLE 5" STRAIGHT EDGE SAWMILL SHINGLES (COLOR TO BE SELECTED BY OWNER)
- (N) 10" SQUARE FLAT FIBERGLASS COLUMN WITH BASE AND CAP PER THE ELEVATIONS, OVER 6"X6" P.T. POST
- (N) WATER RESISTANT GYP. BOARD BELOW Z.F.E. (@ GARAGE AND CRAWL SPACE INTERIOR))
- 19 ASPHALT SHINGLE ROOF. COLOR T.B.D.
- 20 GUTTER/DOWNSPOUT, COLOR T.B.D.
- J ¬
- GAS FIREPLACE TO BE SELECTED BY OWNER
- 22 NON-COMBUSTIBLE FIREPLACE HEARTH
- COMPOSITE DECKING SECURED TO DECK STRUCTURE, SLOPE AWAY FROM HOUSE @ 2% MIN, COLOR T.B.D.

 (N) FIBERGLASS DECK COATING, SLOPE AWAY FROM HOUSE. (FRAMING TO BE TREATED/ DECKING TO BE FIRE
- SPRAYED)

 25 (N) EXTERIOR STAIR TO HAVE 4X4 POSTS (WHERE
- (N) EXTERIOR STAIR TO HAVE 4X4 POSTS (WHERE REQUIRED) W/ 2X12 STRINGERS @ 12" O.C.
- 26 STAIR/DECK GUARDRAIL, 36" MIN. WHITE VINYL FINISH
- EXTERIOR WALL SCONCE, REFER TO REFLECTED CEILING / POWER PLANS ON A2.01 + A2.02
- PULL DOWN ATTIC STAIR/LADDER, CONTRACTOR TO COORDINATE WITH OPENING WITH FRAMING

 CERTAINTEED 5" SHIPLAP SIDING (COLOR TO BE SELECTED BY OWNER)
- 30 BRICK VENEER OVER PRESSURE TREATED PLYWOOD
- VERTICAL BEADBOARD PVC SHIPLAP CUPOLA WITH STANDING SEAM METAL ROOF
- 32 10" PILLAR COLUMN WITH STANDING SEAM ROOF
- 33 PVC PANELLING PER ELEVATION
- CERTAINTEED BOARD AND BATTEN SIDING (COLOR TO BE SELECTED BY OWNER)

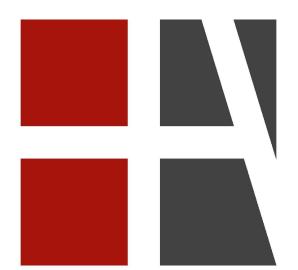

Halliday Architects

Architect: Christopher Halliday email: chris@hallidayarchitects.com Tel: 609.957.6789 Address: P.O. Box 186 Ocean City, NJ 08226

All of the drawings and documents within these sheets are under the ownership of Halliday Architects and are for the sole use of the construction of the pertaining project. They are not to be traced, copied, scanned, reprinted, reproduced, or otherwise used without the expressed and written consent of Halliday Architects.

PROJECT TEAM:

SIGNATURE LI#21A101936000 CHRISTOPHER HALLIDAY

SUBMITTAL INFO./ DATE

PROJECT INFORMATION: 2187

DATE: 11.23.2021

817-819 Park Place

DRAWN BY: CMH

Ocean City, NJ

817-819 Park Place Ocean City, NJ 08226

|OWNER CONTACT| | 817-19 Park Place | | |

817-19 Park Place, LLC 11 E 9th Street Suite 3 Ocean City NJ, 08226


ILOT AND BLOCK | Lot 47 Block 302


SHEET NUMBER AND NAME:


A3.02


Elevations


0' 1' 2' 4'

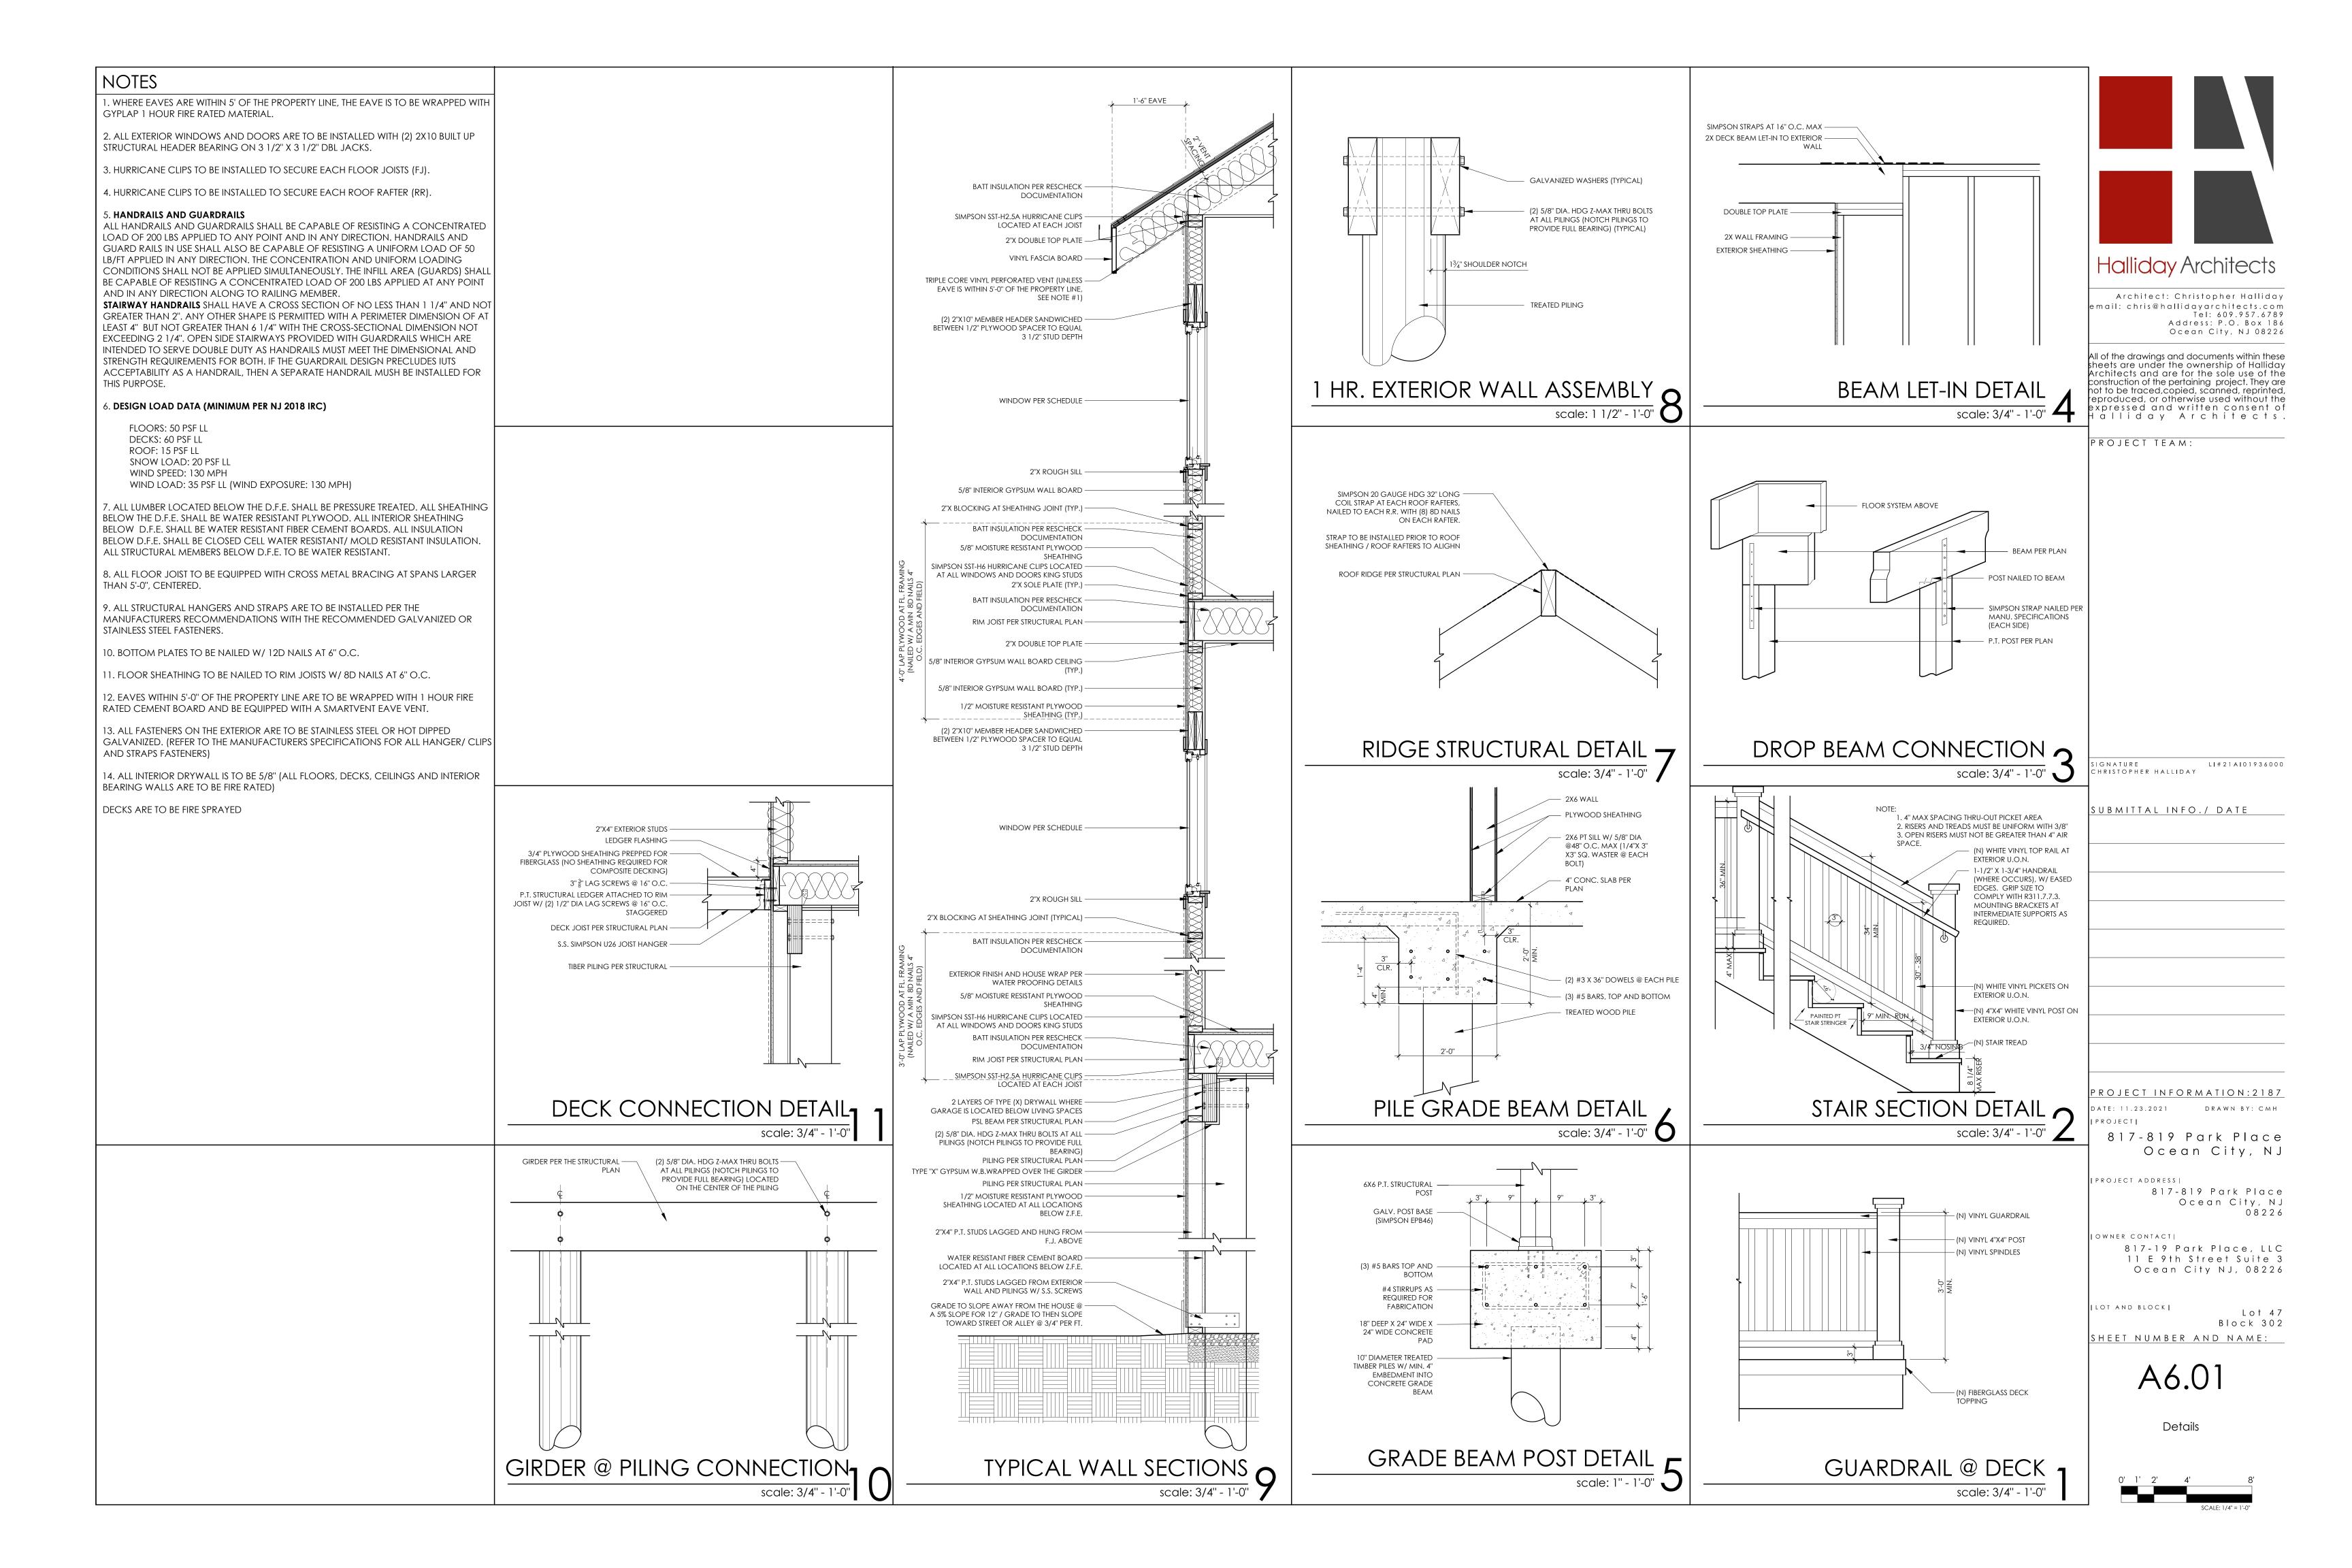


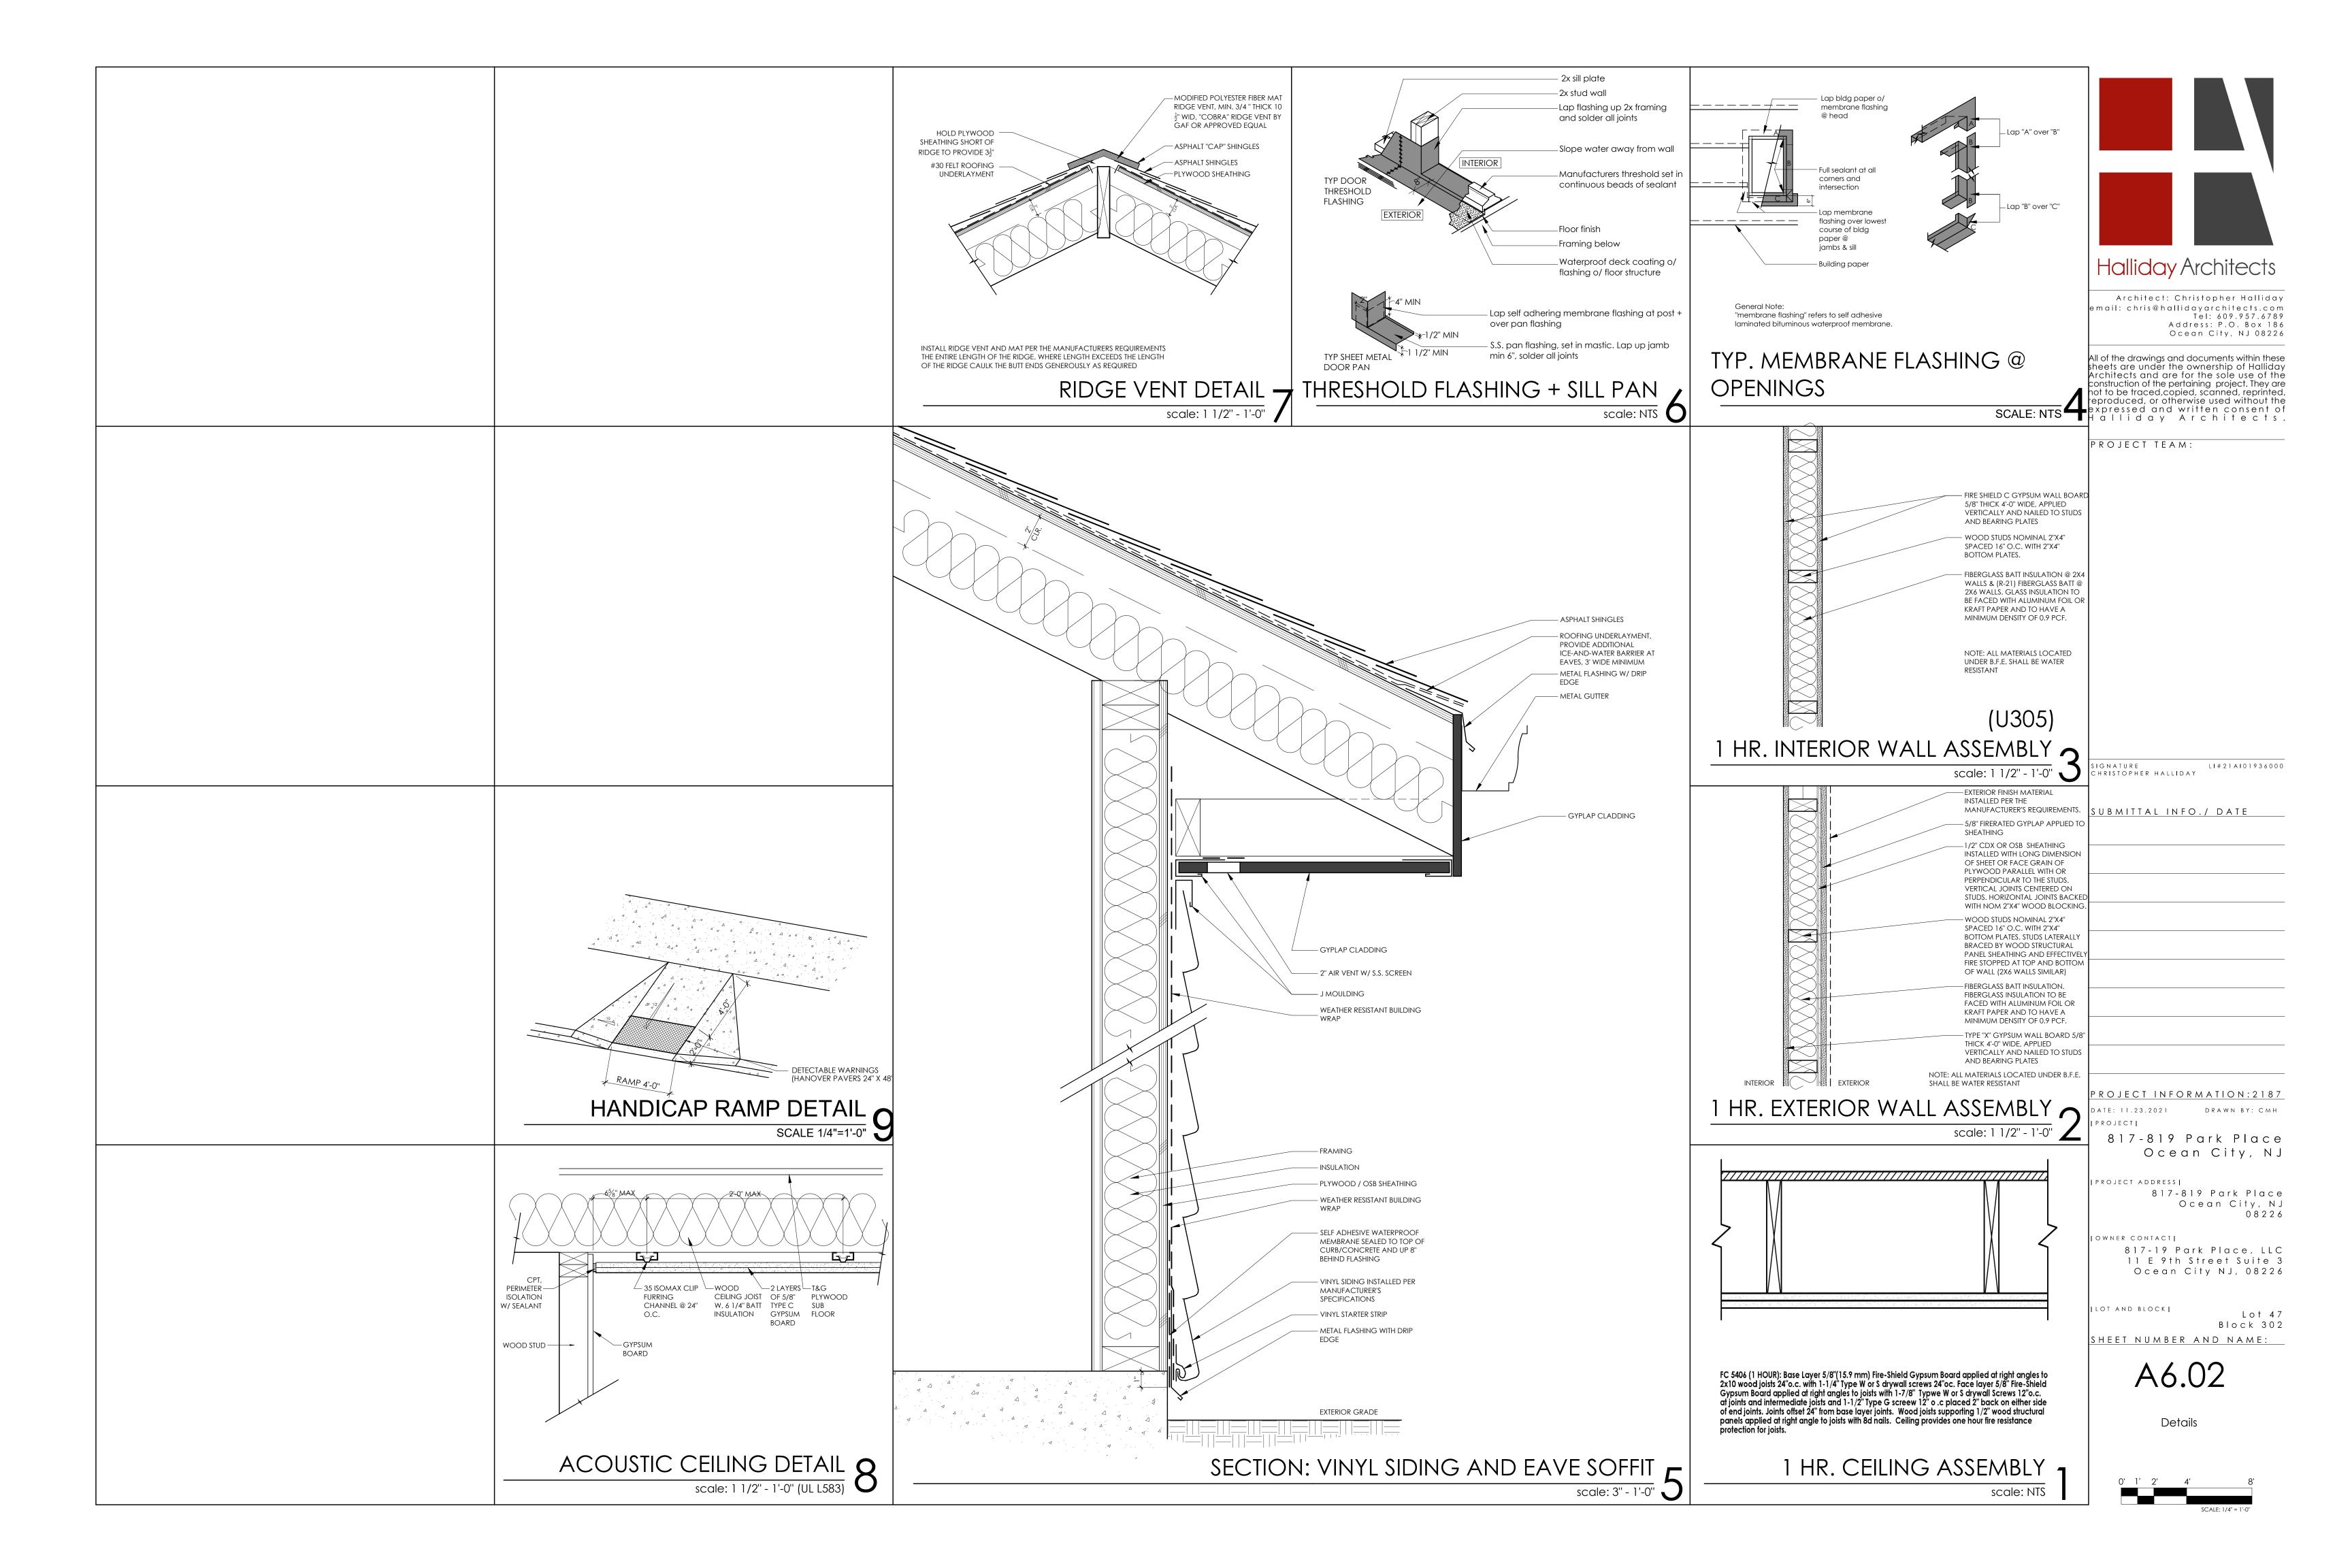

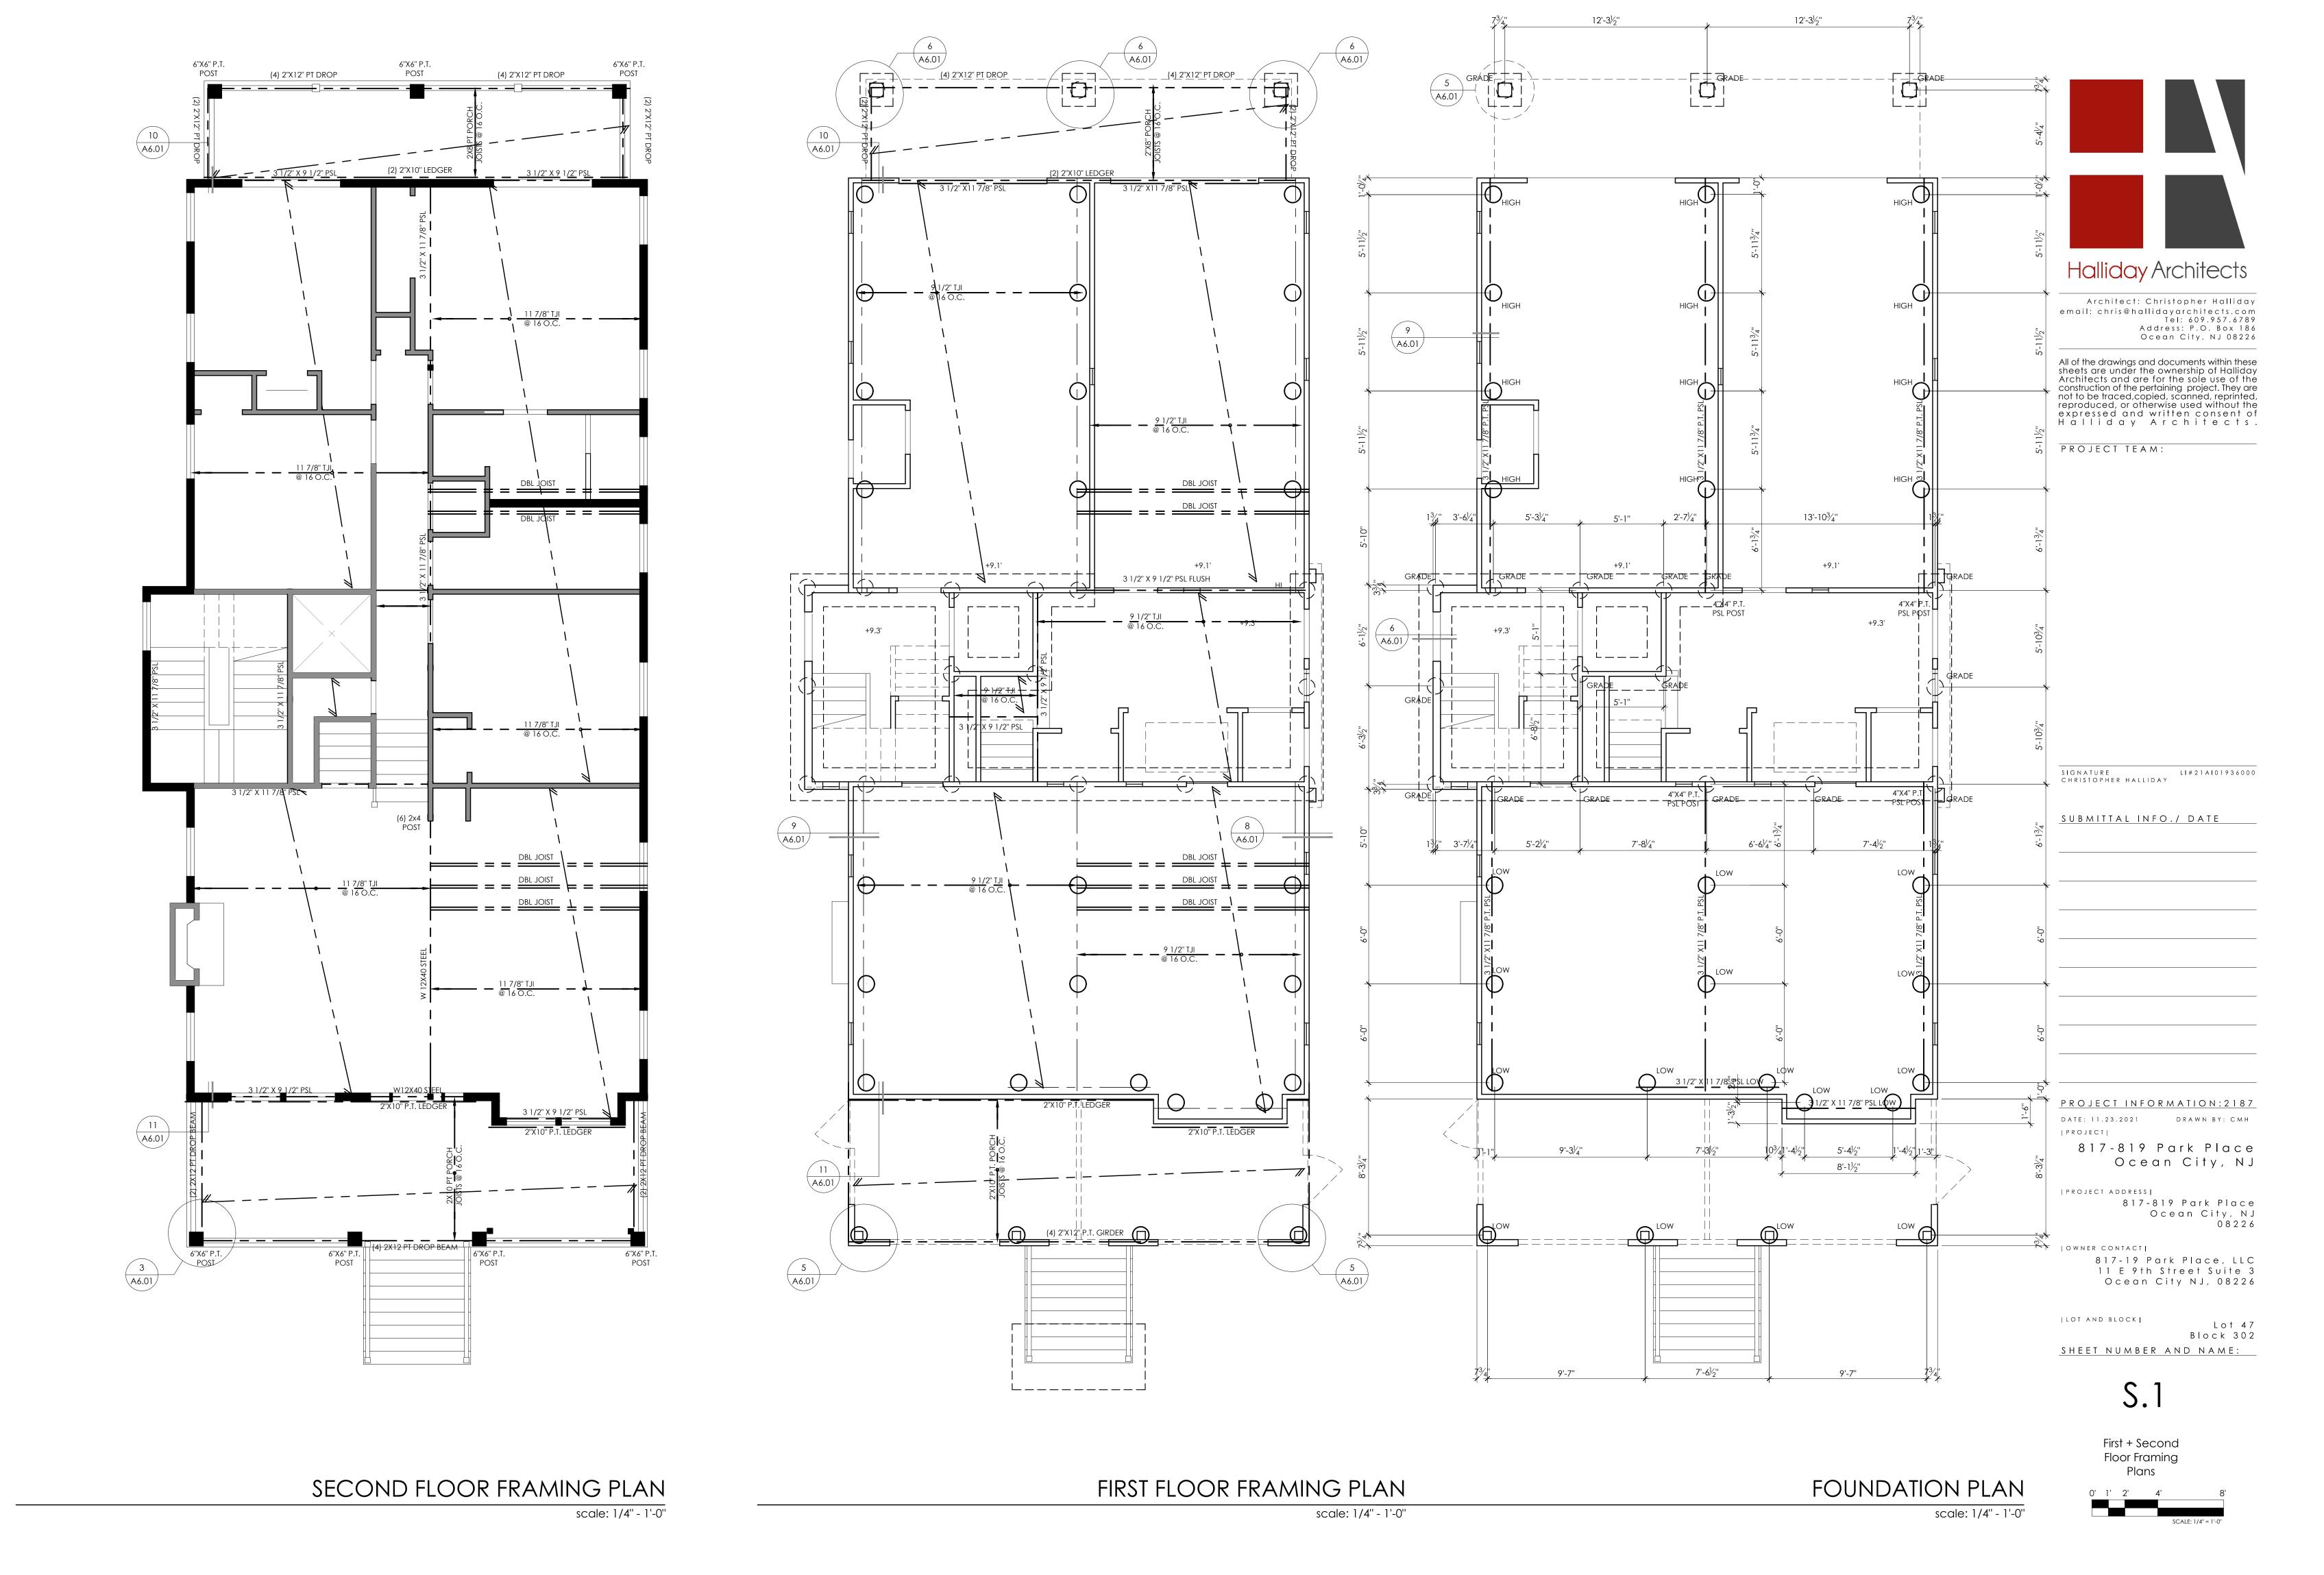

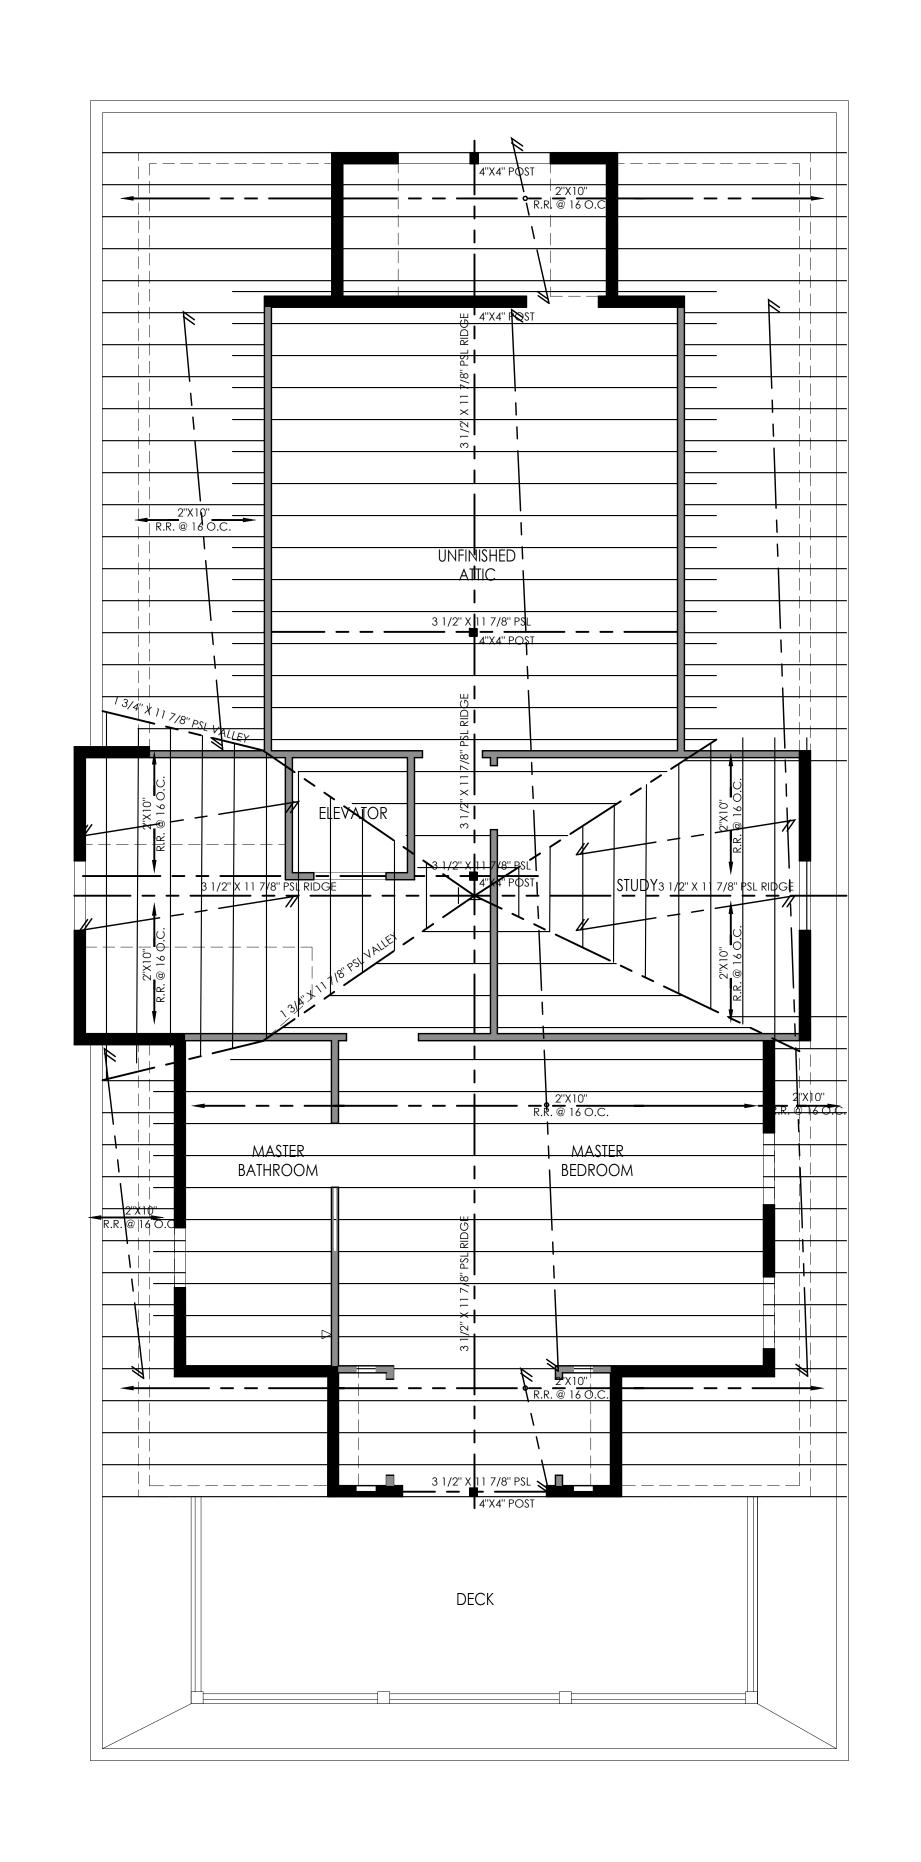

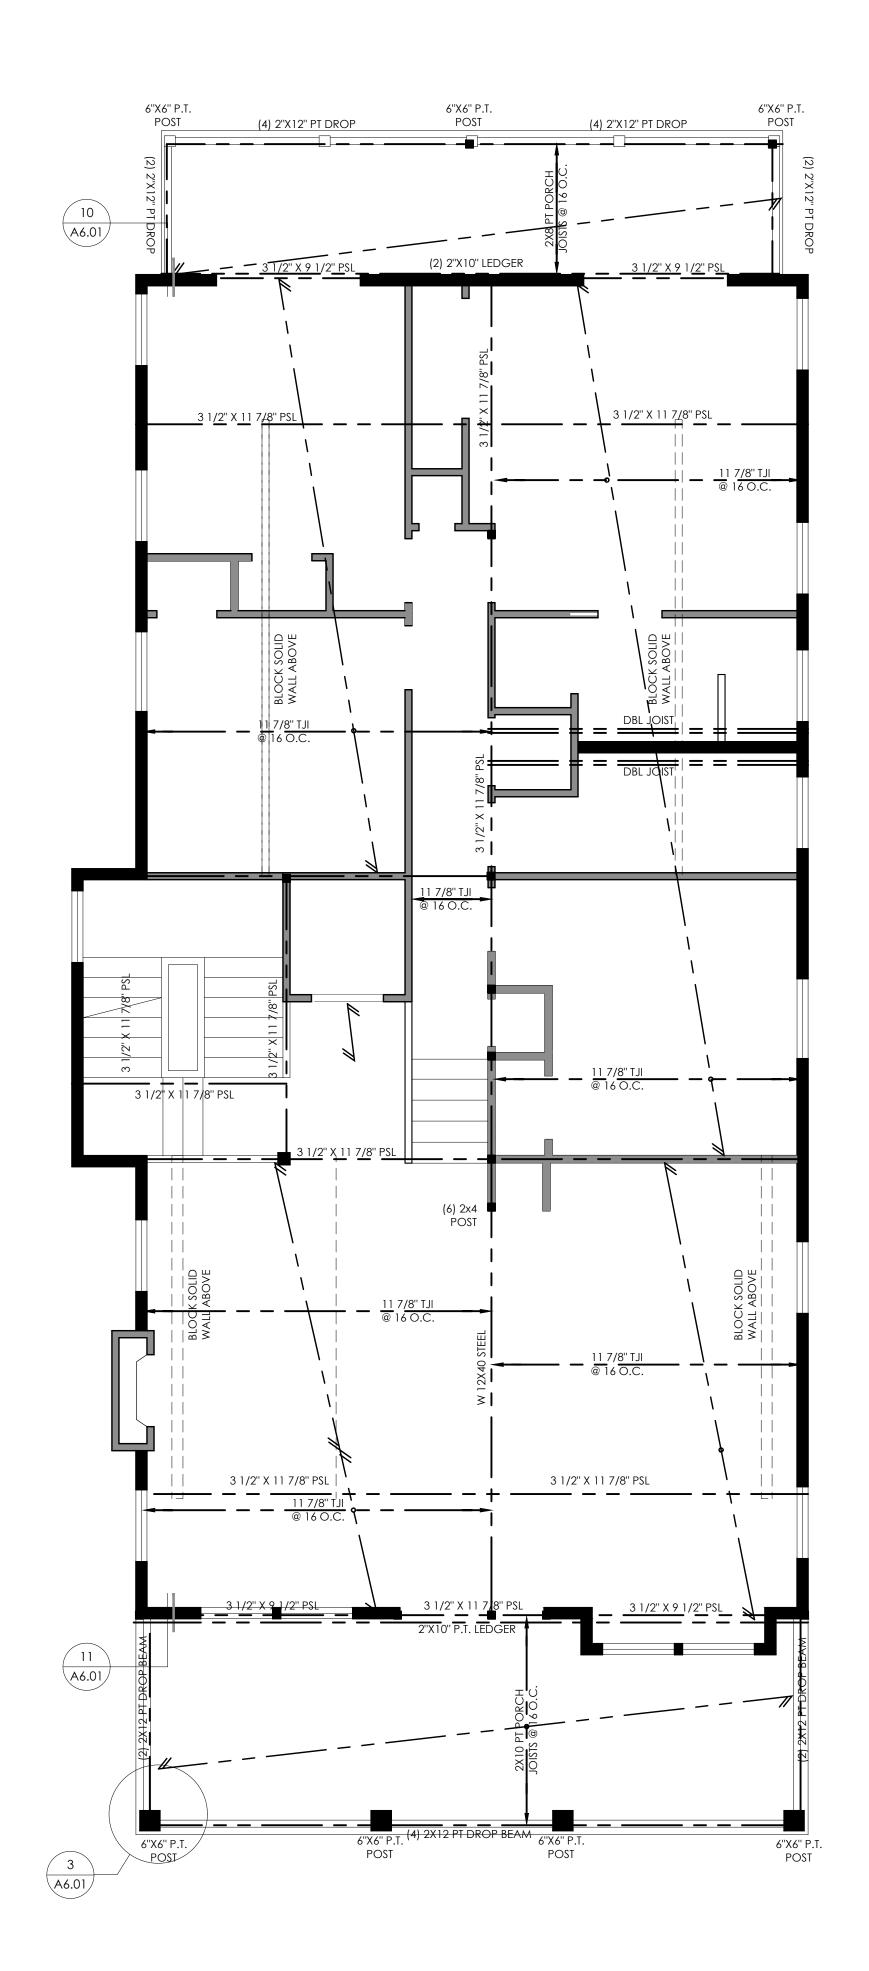

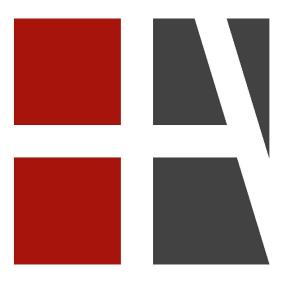

Halliday Architects

Architect: Christopher Halliday email: chris@hallidayarchitects.com Tel: 609.957.6789 Address: P.O. Box 186 Ocean City, NJ 08226

All of the drawings and documents within these sheets are under the ownership of Halliday Architects and are for the sole use of the construction of the pertaining project. They are not to be traced, copied, scanned, reprinted, reproduced, or otherwise used without the reproduced, or otherwise used without the expressed and written consent of Halliday Architects.

PROJECT TEAM:

SIGNATURE CHRISTOPHER HALLIDAY

SUBMITTAL INFO./ DATE

PROJECT INFORMATION: 2187 DATE: 11.23.2021 DRAWN BY: CMH

817-819 Park Place Ocean City, NJ

| PROJECT ADDRESS | 817-819 Park Place Ocean City, NJ 08226

OWNER CONTACT 817-19 Park Place, LLC 11 E 9th Street Suite 3 Ocean City NJ, 08226

LOT AND BLOCK

FRONT SECOND FLOOR DECK TO BE CONSTRUCTED WITH FIRE TREATED LUMBER

Lot 47 Block 302 SHEET NUMBER AND NAME:

Attic Framing Plan + Roof Framing Plan

